

LOCUS MAP

APPLICANT/ARCHITECT: STEVENS MILL, LLC C/O CHINBURG PROPERTIES 3 PENSTOCK WAY NEWMARKET, NH 03857 (603) 868-5995

CIVIL ENGINEER:
ALLEN & MAJOR ASSOCIATES, INC.
400 HARVEY ROAD
MANCHESTER, NH 03103
(603) 627-5500


ARCHITECT:
LASSEL ARCHITECTS
370 MAIN STREET
SOUTH BERWICK, ME 03908
(207) 384-2049

LANDSCAPE ARCHITECT: G2+1 LLC 70 NEW ROAD SAILSBURY, NH 03268 (603) 648-634

LAND SURVEYOR: DOUCET SURVEY INC 2 COMMERCE DRIVE BEDFORD, NH 03110 (603) 614-4060

# SITE DEVELOPMENT PLAN SET STEVENS MILL REDEVELOPMENT

20 CANAL STREET FRANKLIN, NH 03235

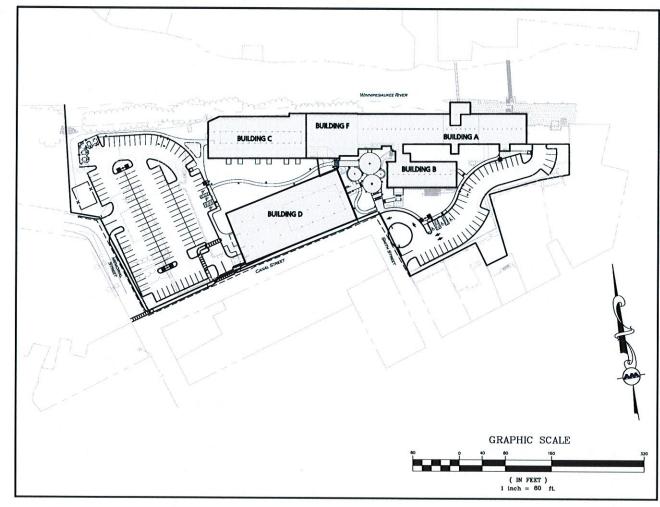

LIST OF DRAWINGS				
DRAWING TITLE	SHEET	ISSUED	REVISED	
EXISTING CONDITIONS PLAN	I OF 4	01/29/2019		
EXISTING CONDITIONS PLAN	2 OF 4	01/29/2019	•	
EXISTING CONDITIONS PLAN	3 OF 4	01/29/2019		
EXISTING CONDITIONS PLAN	4 OF 4	01/29/2019	•	
SITE PREPARATION PLAN	C-101	10/06/2020		
LAYOUT & MATERIALS PLAN	C-102	10/06/2020	-	
GRADING & DRAINAGE PLAN	C-103	10/06/2020	-	
SPOT GRADE PLAN	C-103A	10/06/2020		
SPOT GRADE PLAN	C-103B	10/06/2020		
UTILITIES PLAN	C-104	10/06/2020		
EROSION CONTROL PLAN	C-105	10/06/2020		
DETAILS	C-501	10/06/2020		
DETAILS	C-502	10/06/2020	-	
DETAILS	C-503	10/06/2020	-	
DETAILS	C-504	10/06/2020		
LANDSCAPE PLAN	LA-1.0	10/02/2020		
LANDSCAPE PLAN	LA-1.1	10/02/2020		
LANDSCAPE PLAN	LA-1.2	10/02/2020		
LANDSCAPE PLAN & PLANTING NOTES	LA-1.3	10/02/2020		
LANDSCAPE PLAN PRIVATE PATIOS	LA-1.4	10/02/2020	•	
COURTYARD LANDSCAPE PLAN & DETAILS	LA-2.0	10/02/2020		
PLANT SCHEDULES	LA-3.0	10/02/2020		
SITE LIGHTING PLAN	E-101	10/06/2020		



PROFESSIONAL ENGINEER FOR ALLEN & MAJOR ASSOCIATES, INC.

CHAIRMAN	DATE
SECRETARY	DATE


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ISSUED FOR SITE PLAN REVIEW: OCTOBER 06, 2020



MAP KEY

### ABUTTERS LIST:

TAX MAP NB LOT 117-142 FERRARI FRANKLIN MILLS REALTY LOUIS & CAROLIN FERRARI, TRUSTEES 1B BROADWAY STONEHAM, MA 02180 M.C.R.D. BOOK 3467 PAGE 2235

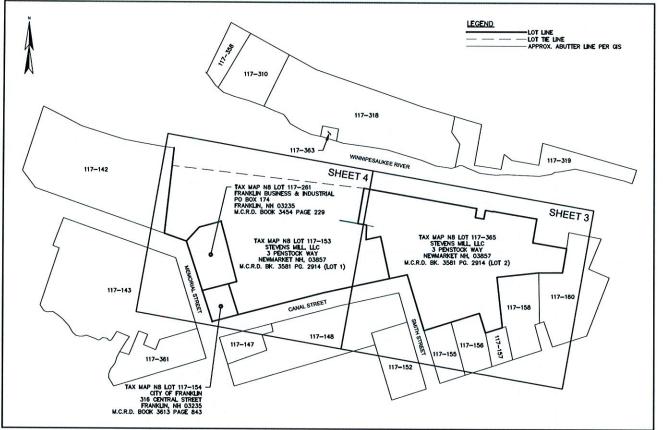TAX MAP NB LOT 117—143
FRANKUN LIGHT AND POWER LTD PART.
c/o CATCH HOUSING
105 LOUDON RD—UNIT 1
CONCORD, NNI 03301
M.C.R.D. BOOK 3508 PAGE 297

TAX MAP N8 LOT 117-147 CITY OF FRANKLIN 316 CENTRAL STREET FRANKLIN, NH 03235 M.C.R.D. BOOK 3614 PAGE 2947

TAX MAP N8 LOT 117-152 CITY OF FRANKLIN 316 CENTRAL STREET FRANKLIN, NH 03235 M.C.R.D. BOOK 2151 PAGE 395 TAX MAP NB LOT 117-155
FFA REALTY HOLDINGS-FRANKLIN
c/o PERMACITYLIFE
361 CENTRAL STREET
FRANKLIN, NH 03235
M.C.R.D. BOOK 3602 PAGE 2856

TAX MAP N8 LOT 117-157 GREMAR, LLC 15 LIBERTY AVENUE FRANKLIN, NH 03235 M.C.R.D. BOOK 1943 PAGE 433

TAX MAP N8 LOT 117-158 JOSE O. & ANN DOMINGUEZ 25 CORN HILL ROAD BOSCAMEN, NH 03303 M.C.R.D. BOOK 2515 PAGE 1607

TAX MAP N8 LOT 117—310
BARBUTO REVOCABLE TRUST
DAMD BARBUTO TRUSTEE
515 WEST MAIN STREET
TILTON, NH 03278
M.C.R.D. BOOK 2145 PAGE 1680


TAX MAP NB LOT 117-318 CITY OF FRANKLIN 316 CENTRAL STREET FRANKLIN, NH 03235 M.C.R.D. BOOK 2182 PAGE 1431

TAX MAP N8 LOT 117-319
FRANKIN POWER, LLC
c/o EAGLE CREEK RENEWAL ENERGY
PO BOX 167
NESHKORO, WI 54960
M.C.R.D. BOOK 3394 PAGE 844

TAX MAP NB LOT 117-358 CITY OF FRANKLIN 316 CENTRAL STREET FRANKLIN, NH 03235 M.C.R.D. BOOK 3563 PAGE 177

TAX MAP N8 LOT 117-361 FRANKLIN POWER, LLC c/o EAGLE CREEK RENEWAL ENERGY PO BOX 167 NESHKORO, W 54960 M.C.R.D. BOOK 2338 PAGE 1300

TAX MAP N8 LOT 117-363 CITY OF FRANKLIN 316 CENTRAL STREET FRANKLIN, NH 03235 M.C.R.D. BOOK 3563 PAGE 178

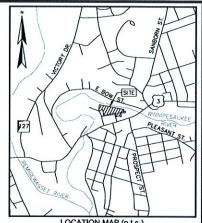

LOCATION MAP (n.t.s.)





### **EXISTING CONDITIONS PLAN**

FOR CHINBURG BUILDERS, INC.

FRANKLIN BUSINESS CENTER TAX MAP N8 LOTS 117-153, 117-365, 117-261 & 117-154

SMITH, CANAL, & MEMORIAL STREET FRANKLIN MERRIMACK COUNTY NEW HAMPSHIRE

1 09/03/20 ADDED BOUNDARY/UTILITY/FEMA INFO B.T.
NO. DATE DESCRIPTION BY


DRAWN BY:	W.D.C.	DATE: JANUARY 29, 2019
CHECKED BY:	M.J.C.	DRAWING NO.: 5482B
JOB NO.:	5482	SHEET OF 4



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- 1. REFERENCE: FRANKLIN BUSINESS CENTER
- FIELD SURVEY PERFORMED BY E.J.S. & P.J.M. DURING MARCH & APRIL 2018 USING A TRIMBLE S7 TOTAL STATION
  WITH A TRAMBLE TSC3 DATA COLLECTOR AND A TRIMBLE DINI DIGITAL AUTO LEVEL ADDITIONAL FIELD SURVEY
  PERFORMED BY J.M.L & J.C.M. & D.L IN OCTOBER 2018 USING A TRIMBLE S5 TOTAL STATION WITH TRIMBLE TSC3
  DATA COLLECTOR. ADDITIONAL FIELD SURVEY PERFORMED BY P.C.L. DURING AUGUST 2020 USING A TRIMBLE SS
  TOTAL STATION. TRAVERSE ADJUSTMENT BASED ON LEAST SQUARES ANALYSIS.
- ADDITIONAL FIELD SURVEY PERFORMED BY M.J.C. IN MARCH & APRIL 2018 USING A LEICA HOS SCANNER. REGISTRATION ADJUSTMENT BASED ON LEAST SQUARE ANALYSIS.
- HORIZONTAL DATUM BASED ON NEW HAMPSHIRE STATE PLANE (2800) NADB3(2011) DERIVED FROM REDUNDANT GPS
  OBSERVATIONS UTILIZING THE KEYNET GPS VRS NETWORK.
- VERTICAL DATUM IS BASED ON NAVD88 PER NOS BENCHMARKS: K-13-USGS-1925 (PUBLISHED NAVD88 ELEVATION=334.20 FT) AND X-3-1933 (PUBLISHED NAVD88 ELEVATION=332.85).
- PROPER FELD PROCEDURES WERE FOLLOWED IN ORDER TO GENERATE CONTOURS AT 2' INTERVALS, ANY MODIFICATION OF THIS INTERVAL WILL DIMINISH THE INTEGRITY OF THE DATA, AND DOUCET SURVEY WILL NOT BE RESPONSIBLE FOR ANY SUCH ALTERATION PERFORMED BY THE USER.
- 7. UNDERGROUND UTILITIES SHOWN HEREON ARE BASED ON OBSERVED PHYSICAL EVIDENCE AND PAINT MARKS FOUND ON-SITE.
- THE ACCURACY OF MEASURED UTILITY INVERTS AND PIPE SIZES/TYPES IS SUBJECT TO NUMEROUS FIELD CONDITIONS, INCLUDING; THE ABILITY TO MAKE VISUAL OBSERVATIONS, DIRECT ACCESS TO THE VARIOUS ELEMENTS, MANHALE CONFIDENTION, ETC.
- 10. DEED MCRD 3581-2914 (SHEET 7 ITEM (q)) REFERS TO RIGHTS RESERVED BY PSNH IN DEED 949-448. DEED 949-448 (SHEET 4 ITEM (q)) CALLS FOR AN EASEMENT THAT BEGINS N'LY OF THE RIVER AND EXTENDS S'LY THROUGH POLES 234/1, 234/1A, 234/2A, 234/3A, OUT TO POLE 234/4 ON THE WESTERLY SIDE OF MEMORIAL STREET, AND CONTINUING S'LY FROM THERE.
- 11. SEE DEED 3581-2914 (SHEET 5 PARAGRAPH 2) AND REFERENCE PLAN 1 FOR DETAILS ON 50' WIDE UTILITY & RIVER ACCESS EASEMENT
- 12. SEE REF. PLAN 4 AND MCRD DEED 1996—461 FOR DETAILS ON PARKING EASEMENT AND ACCESS TO PARKING EASEMENT (BENETITING LOT 117-261). NOTE THAT THE SOMEWHAT TRIANGULAR—SHAPED NON EXCLUSIVE EASEMENT AREA "SHOWN HEREON IS DESCRIBED IN SAID DEED BUT IS NOT ILLUSTRATED ON SAID PLAN.
- SEE REFERENCE PLAN 4 AND MCRD DEED 1996-461 (SHEET 1 PARAGRAPH 5) FOR DETAILS ON ACCESS EASEMENT RESERVED ACROSS LOT (117-261) BENEFITTING LOT (117-153).
- 14. APPROXIMATE LOCATION OF BURIED PENSTOCK SHOWN HERE PER REFERENCE PLANS 1, 2, 4, AND 5. REFER ALSO TO MORD DEED 1475—887 FOR A PERMANENT EASEMENT FROM THE CITY OF FRANKLIN TO FRANKLIN INDUSTRIAL COMPIELS, INC. 30 FEET IN WIDTH ALONG THE ENTIRE LENGTH OF CANAL STREET, INDUSTRIAL FOR PROSTOCK. NOTE THAT THE DIED STATES IT IS UNDERSTOOD BY THE PARTIES THAT THE 30 FEET MOTH OF THE EASEMENT GRANTED ENCOMPASSES THE FULL WOTH OF THE CANAL STREET RIGHT—OF-WAY: SEE ALSO MORD DIED 1881—1075 FOR ADDITIONAL RIGHTS AND EXSEMENTS ASSOCIATED WITH THE PENSTOCK.
- 15. FOR CANAL STREET, SEE ALSO DEED MCRO 369-330 WHICH CONVEYS A TRACT OF LAND TOGETHER WITH THE FEE OF SAID CANAL STREET TO THE MIDDLE THEREOF AND THE RIGHT TO USE SAID STREET AS NOW USED...\*
- 16. SEE MORD DEED 1910—198 FOR DETAILS ON 12' WIDE UTILITY EASEMENT BEGINNING AT A POINT ON IN'LY SIDE OF MEMORIAL ST ACROSS FROM PSH POLE #234/1 LOCATED ON THE S'LY SIDE OF THE ROAD, AND THEM EXTENDING IN'LY 150 FT +/- TO PSM POLE #234/2.
- 17. SEE MCRD DEED 1510-962 FOR DETAILS ON 10-FOOT WIDE UTILITY EASEMENT ENCOMPASSING POLES 234/2 AND 234/2-1.
- 18. SEE MCRO DEEDS 1347-45 AND 1350-655 FOR DETAILS ON A 20-FOOT WIDE SEWER EASEMENT RESEMBLING THE CONFIGURATION SHOWN HEREON. NOTE ALSO THAT MCRO DEED 1345-403 DESCRIBES A 20-FOOT SEWER EASEMENT WITH A SLIGHTLY DIFFERENT CONFIGURATION THAT DOES NOT APPEAR TO CORRESPOND WITH THE LOCATIONS OF THE SMM STRUCTURES LOCATED FOR THIS SURVEY.
- 19. SEE MORD DEED 3581-2914 (SHEET 7): SUBJECT PROPERTY INCLUDES THE PORTIONS OF THE BUILDING ABOVE THIS BASEMENT-LEVEL POWER HOUSE #1-THAT ARE AT ELEVATIONS GREATER THAN 317.69 FEET (NGV029). NOTE THAT THIS ELEVATION EQUATES TO 317.20 FEET MAYOBE (REPER TO NOTE 5 HEREON). THE SEABLEMT-LEVEL SPACE IN THE POWER HOUSE #1-PART OF THE BUILDING (ANY PORTIONS AT OR BELOW ELEVATION 317.69 FEET NOV029) WHERE NOT CONVEYED AS PART OF THE LOCUS PROPERTY IN DEED 3581-2914. SEE ALSO ABOVE REPERENCED DEED (SHEET 5 NOTE 4) DESCRIBING PERMANENT RIGHT AND EASEMENT TO PASS & REPASS OVER THE PREMISES AND BUILDINGS. FOR REASONABLE ACCESS TO CENERATOR ROOMS AND OTHER PORTIONS OF SAID HYDRO-ELECTRIC FACILITY... SEE ALSO REPERENCE FLAM 1.
- 20. MCRD DEED 3581-2914 DESCRIBES SEVERAL RIGHTS ASSOCIATED WITH THE DAM AND THE WATER, INCLUDING THE RIGHT OF OTHERS TO ENTER, REPAIR, AND MAINTAIN THE DAM & FOOTBRIDGE. SAME DEED SHEET (HERET 7 HER (b)) REFERS TO RIGHTS & RESEMBLYS GRANTED IN MCRD DEED 469-1 WHICH PERMIT OTHERS TO INSTALL 2-PHOT HIGH FLASHBOARDS TO RAISE THE LEVEL OF WATER IMPOUNDED BY THE DAM. ADDITIONAL REPERBINGS TO THE DAM & WATER PRINLEDCE & FLOWAGE RIGHTS ARE FOUND IN MORD DEEDS 1475-691, 344-30 AND 949-448.
- 21. MCRD DEED 3581-2914 (SHEET 5, PARAGRAPH 2) DESCRIBES THE PERMANENT RIGHT TO DRAW WATER FROM THE RIVER AT TWO POINTS IN ORDER TO CONVEY WATER THROUGH THE PENSTOCKS. SEE ALSO REFERENCE PLAN 1.
- 22. MCRD DEED 1996-459 CONVEYS AN EMERGENCY ACCESS EASEMENT FROM SMITH STREET BENEFITTING LOT 117-160. SAID EASEMENT USES THE EXISTING ROADWAY GENERALL DEPICTED AS THE AREA SHOWN AS THE 'UNDERGROUND PRISTOCK' ON REFERENCE FLAN 4.
- 23. MORD DEED 3581-2914 (SHEET 5 NOTE 5) DESCRIBES RIGHTS TO A PARKING EASEMENT (BENEFITTING THE HYDRO-ELECTRIC FACILITY) IN THIS AREA, AS WELL AS RIGHTS OF INGRESS & EGRESS BETWEEN THIS AREA AND SMITH STREET.
- 24. MCRO DEED 3581-2914 DESCRIBES THE DIVISION LINE BETWEEN LOTS 1 & 2 (NOW TAX MAP N8 LOT 117-153 AND TAX MAP N8 LOT 117-365 RESPECTIVELY) AS BEING ALONG THE PARTY WALL BETWEEN THE SEPARATE MILL BULDINGS. COURSES SHOWN HEREON OFFER SLIGHTLY FROM THOSE CALLED FOR IN THE DOLSES SHOWN HEREON WERE DERIVED FROM DATA OBTAINED FROM OUR 3D LASER SCAN SURVEYS DONE INSIDE THE BULDING ALONG THOSE PARTY WALLS.
- 25. THIS BUNP-OUT AREA IS SHOWN AS PART OF THE LOCUS PROPERTY ON REFERENCE PLANS 4 & 5. BUT IT IS NOT SHOWN AS PART OF THE LOCUS ON REF. PLANS 1 & 2. FOR DESCRIPTION OF THIS PARCE. IN THE CHAIN OF THIS PARCE IN THE CHAIN OF THE CHAIN O
- 26. MCRO DEED 1910-196 DESCRIBES A 12-FOOT WIDE UTILITY EASEMENT FROM POLE 237/3 TO POLE 237/3-1A.
- 27. THIS IS NOT A TITLE REPORT. OTHER RIGHTS MAY EXIST.
- 28. PARCES SHOWN FALL WITHIN ZONES "X" & "AE" (WITH BASE FLOOD ELEVATIONS) PER FIRM MAP #33013C0159E DATED APRIL 19, 2010.

- "PROPOSED SUBDIVISION FRANKLIN INDUSTRIAL COMPLEX" DATED FEB. 6, 1986 BY J.R. BLAIS ASSOCIATES. MCRO PLAN 8915
- "IMPROVEMENTS PLAN PREPARED FOR FRANKLIN INDUSTRIAL COMPLEX, INC. HYDRO-ELECTRIC FACILITY FRANKLIN, NEW HAMPSHIRE" DATED DECEMBER 26, 1990 BY TF MORAN, INC. MCRD PLAN 12116
- "BOUNDARY SURVEY FOR ROBERT GREVOIR CENTRAL ST. FRANKLIN, N.H. MERRIMACK COUNTY" DATED 10 SEPT 1991 BY RICHARD L. LEPENE & ASSOCIATES. MICRO PLAN 12305
- TAX MAP 001-117, LOT 153 SUBDIVISION PLAN FOR SOUTHEASTERN PROPERTIES, INC. 20 CANAL STREET, FRANKIN, MERRIMACK COUNTY, NEW HAMPSHIRE! DATED AUGUST 7, 1998 AND REVISED SEPTEMBER 16, 1998 BY LEPIDE ENGERERING & SURVEYING. MCRO PLAN 14558.
- "MAP 117, LOT 143 RESTRICTED AREA PLAN FOR EDWARD J. FORSTER 100 MEMORIAL STREET MERRIMACK CO. FRANKLIN, N.H." DATED MAY 26, 2006 BY DAVID B. KRAUSE, LLS. MCRD 18113.

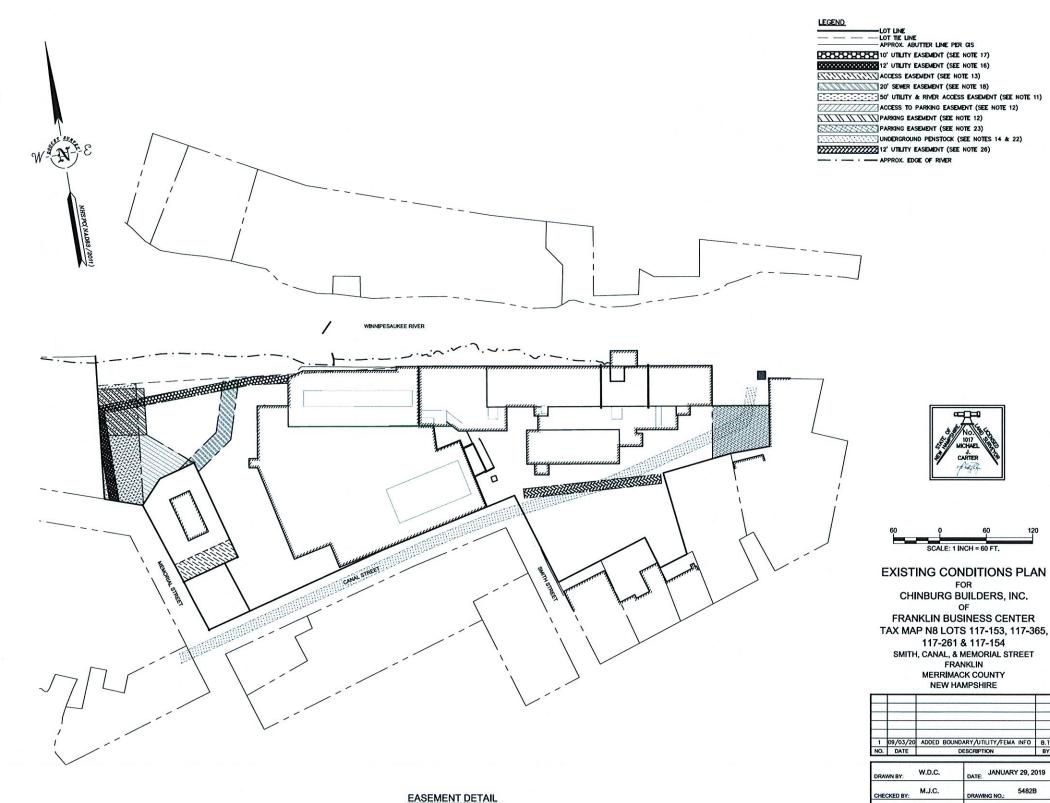

SCALE: 1 INCH = 60 FT.

FOR

CHINBURG BUILDERS, INC.

117-261 & 117-154

FRANKLIN MERRIMACK COUNTY

**NEW HAMPSHIRE** 

DOUCET.


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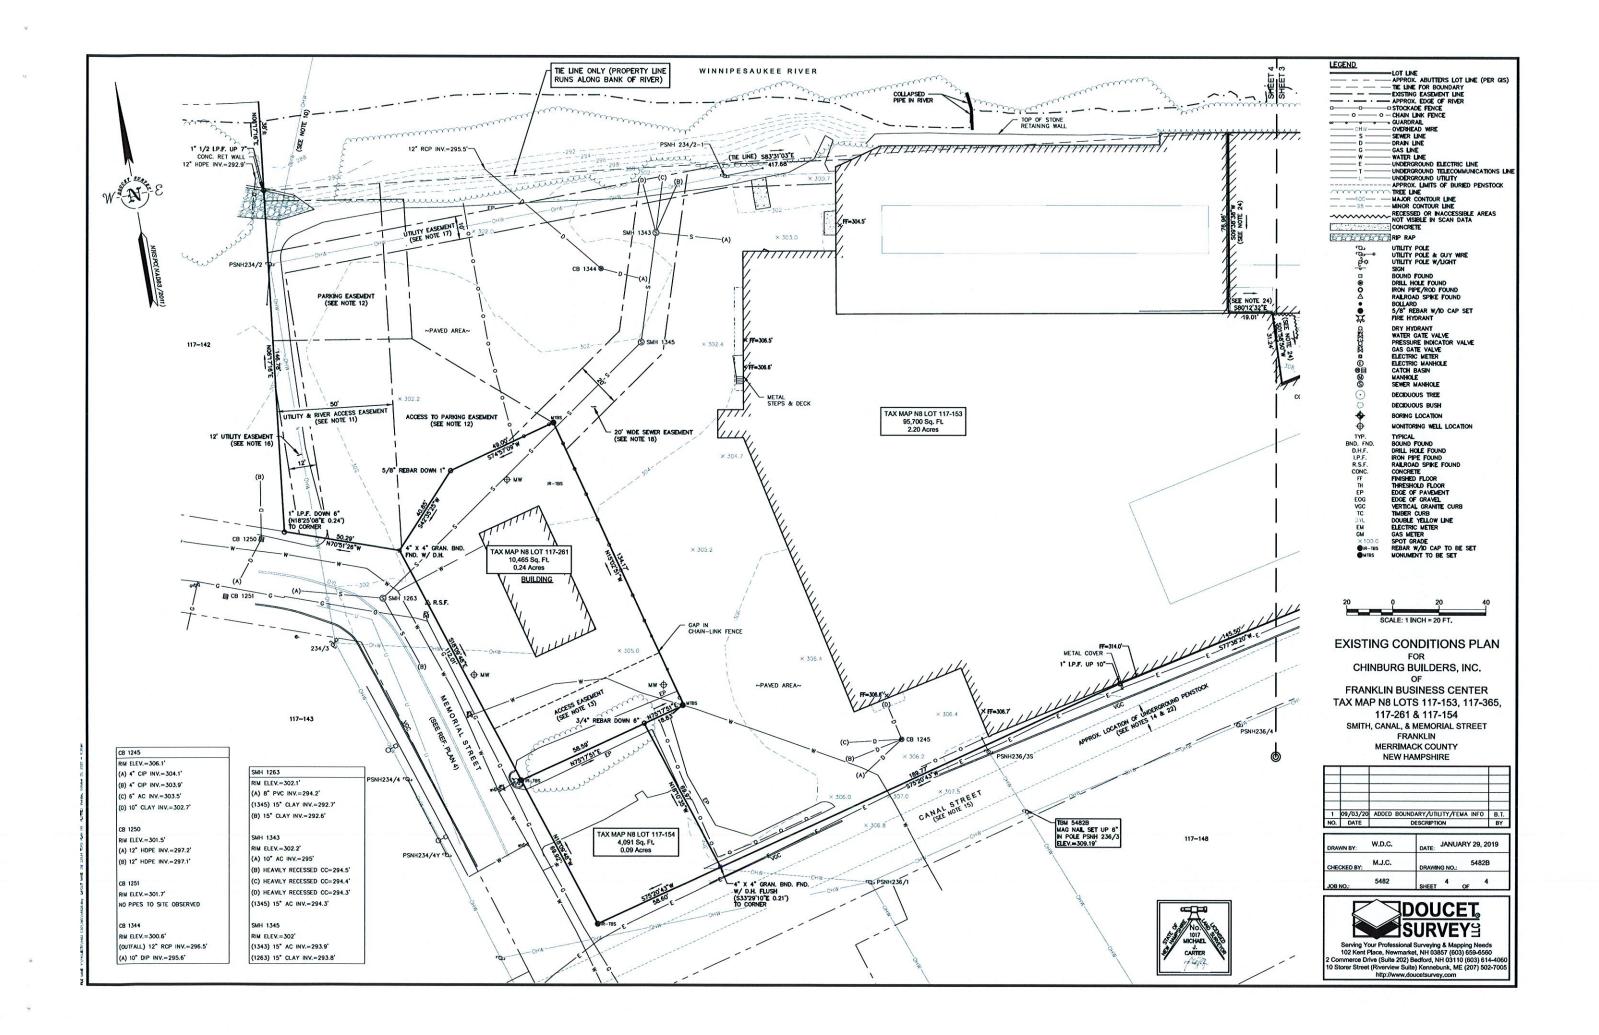
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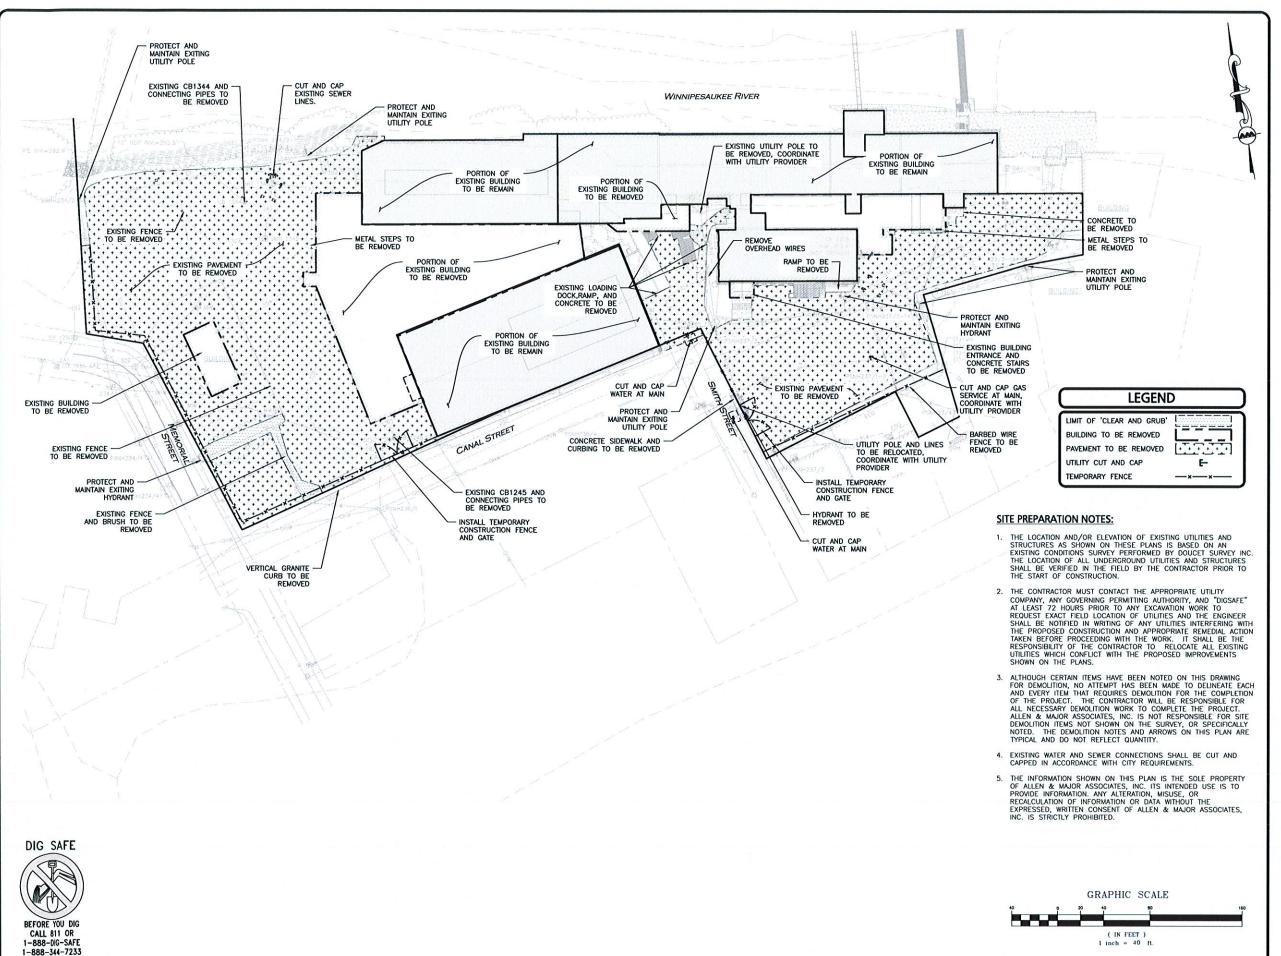
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M.J.C.

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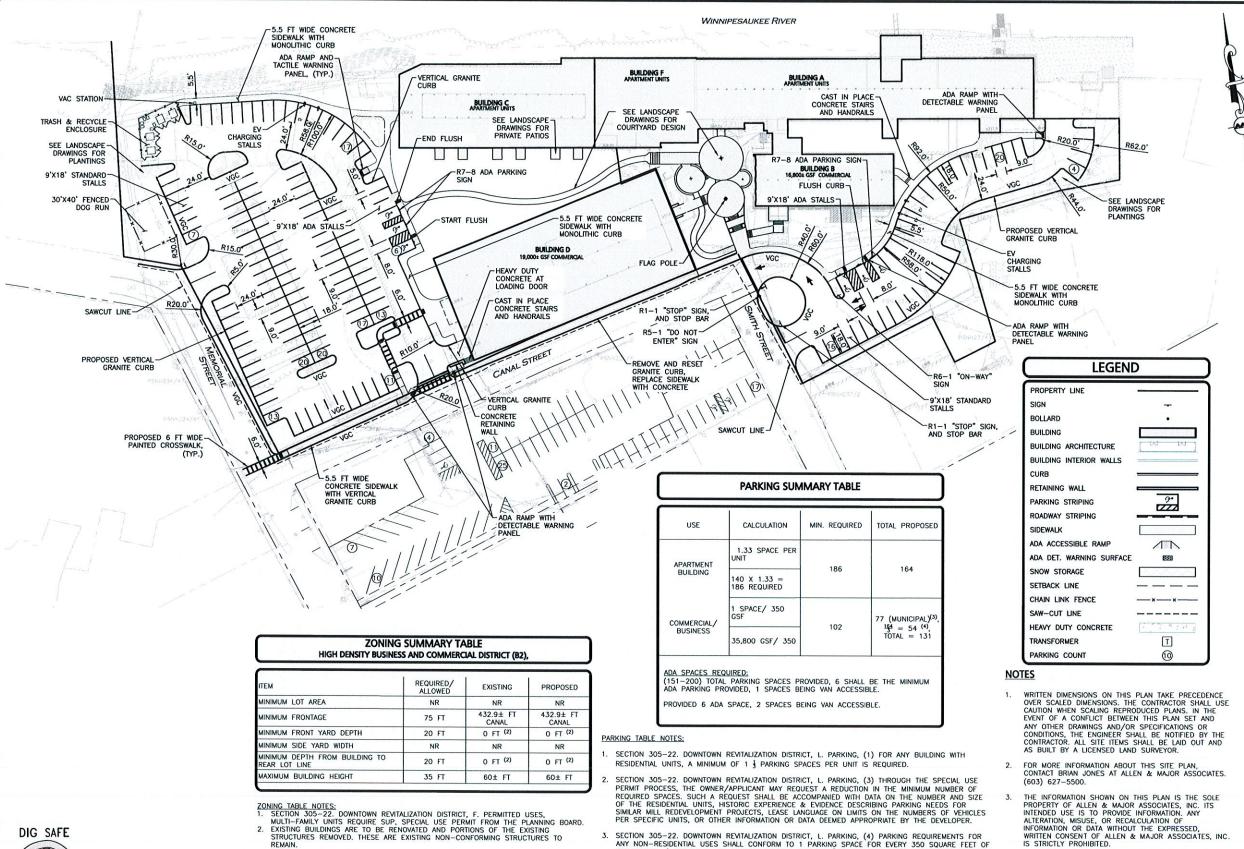
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DRAWING TITLE:

SITE PREPARATION PLAN C-101



SECRETARY PPLICANT\OWNER ROJECT NO. 2748-02 DATE: SCALE: DESIGNED BY VOBURN, MA . LAKEVILLE, MA . MANCHESTER, N

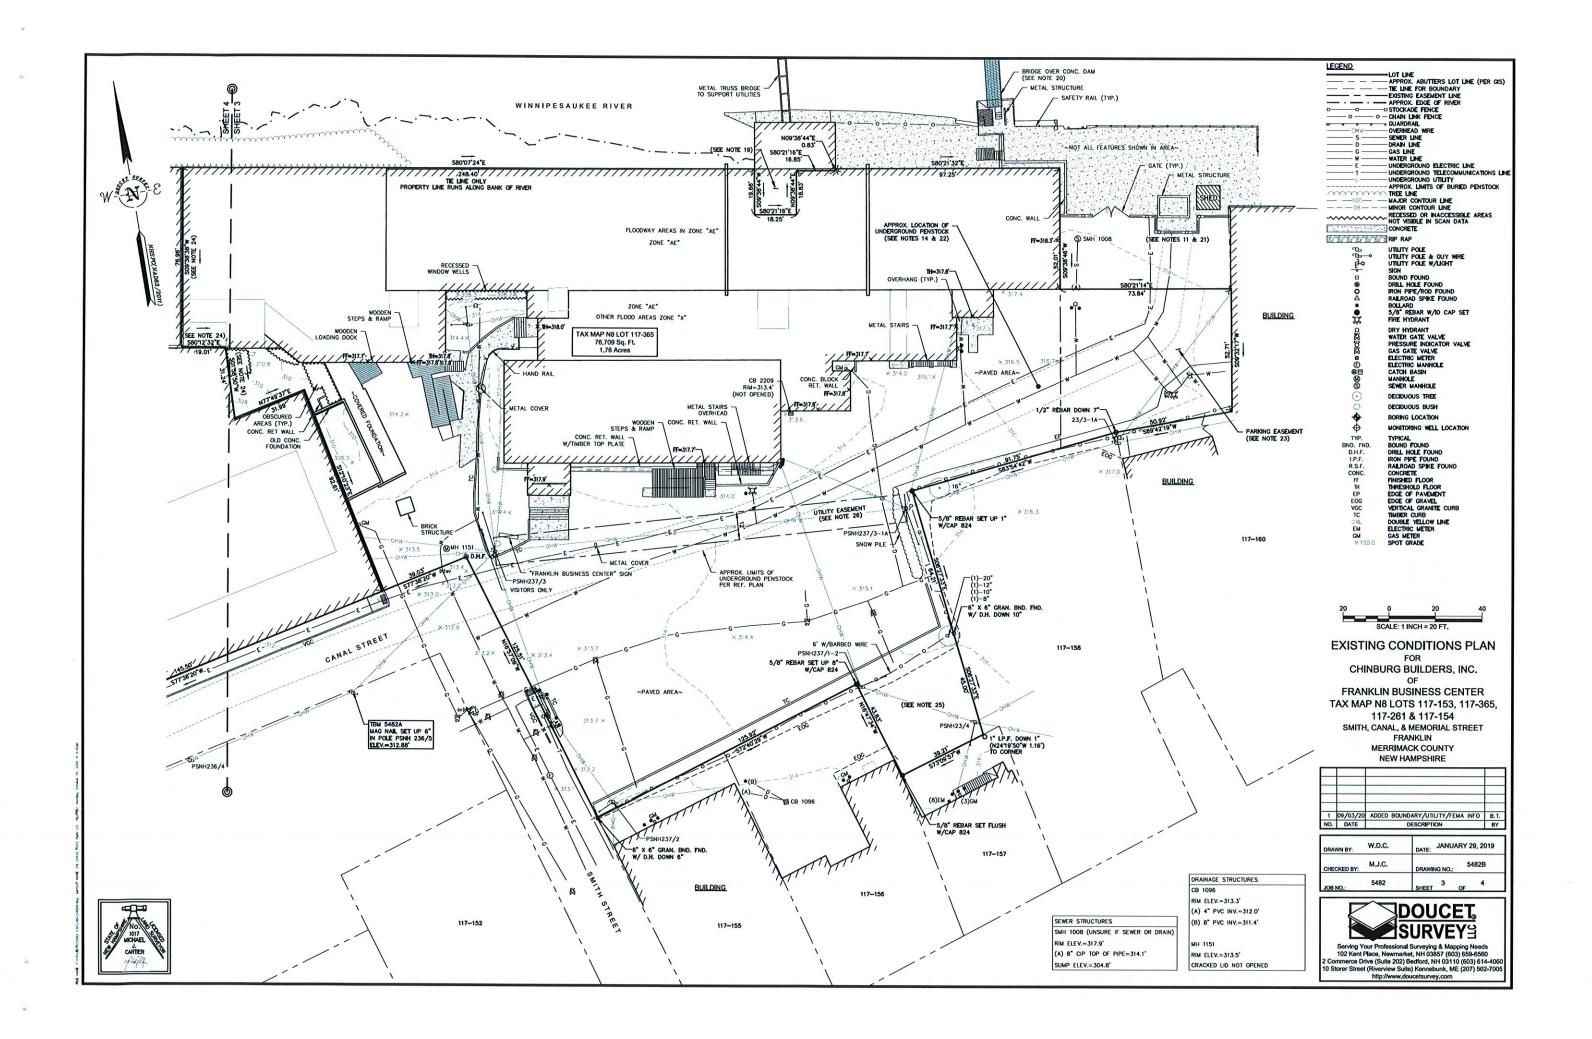DATE DATE OF APPROVAL PROFESSIONAL ENGINEER FOR ALLEN & MAJOR ASSOCIATES, INC. 10-06-2020 ISSUED FOR SITE PLAN REVIEW REV DATE DESCRIPTION STEVENS MILL, LLC C/O CHINBURG PROPERTIES **3 PENSTOCK WAY NEWMARKET, NH 03857** STEVENS MILL **REDEVELOPMENT 20 CANAL STREET** FRANKLIN, NH 03235

APPROVED - CITY PLANNING STAFF

1" = 40' DWG. NAME: ARM CHECKED BY



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SNOW IS TO BE REMOVED FROM THE SITE WHEN THERE IS NOT SUFFICIENT SPACE ON SITE OR WHEN THE WILL NOT BE SUFFICIENT SPACE IN THE EVENT OF EXCESSIVE SNOW FALL.

GRAPHIC SCALE

( IN FEET )

10-06-202

LAYOUT & MATERIALS PLAN C-102

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BEFORE YOU DIG

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4. SECTION 305-22. DOWNTOWN REVITALIZATION DISTRICT, L. PARKING, (6) THE PRECEDING SUBSECTION NOTWITHSTANDING, THE OWNER/DEVELOPER OF A MULTI-USE BUILDING CONTAINING BOTH RESIDENTIAL AND NONRESIDENTIAL USES MAY UTILIZE UP TO 1/3 OF THE PARKING SPACES REQUIRED FOR THE RESIDENTIAL COMPONENT TOWARDS THE REQUIRED NUMBER OF NONRESIDENTIAL SPACES.

SPECIFIC ISSUES AND CIRCUMSTANCES.


ANT NON-RESIDENTIAL USES SHALL CONFORM TO I PARKING SPACE FOR EVERY 350 SQUARE FEEL OF COMMERCIAL / BUSINESS USE. WHERE MUNICIPAL PARKING [NOT INCLUDING ANY OVER-NIGHT PARKING] IS AVAILABLE WITHIN 400 FEET OF THE PROPOSED USE, THEN THESE MUNICIPAL SPACES MAY BE COUNTED TOWARDS THE TOTAL NUMBER OF NON-RESIDENTIAL SPACES REQUIRED. THE PLANNING BOARD RESERVES THE RIGHT TO DEVIATE FROM THE PARKING REQUIREMENTS IN THE ZONING ORDINANCE BASED ON A REVIEW AND APPROVAL OF A SITE PLAN OR SUP AND TAKING INTO ACCOUNT PROJECT


- PLAN NOTES:


  1. THE LOCATIONS OF EXISTING UNDERGROUND UTILITIES ARE SHOWN IN AN APPROXIMATE WAY ONLY AND HAVE NOT BEEN INDEPENDENTLY VERIFIED BY THE OWNER OR IT'S REPRESENTATIVE. THE CONTRACTOR SHALL
  DETERMINE THE EXACT LOCATION OF ALL EXISTING UTILITIES BEFORE
  COMMENCING WORK, AND AGREES TO BE FULLY RESPONSIBLE FOR ANY AND ALL DAMAGES WHICH MIGHT BE OCCASIONED BY THE CONTRACTOR'S FAILURE TO EXACTLY LOCATE AND PRESERVE ANY AND ALL UNDERGROUND UTILITIES.
- CONTRACTOR IS RESPONSIBLE FOR DEMOLITION OF EXISTING STRUCTURES INCLUDING REMOVAL OF ANY EXISTING UTILITIES SERVING THE STRUCTURE. UTILITY CONNECTIONS SHOULD BE COORDINATED WITH THE MEP PRIOR TO CONSTRUCTION.
- 3. EXISTING DRAINAGE STRUCTURES TO REMAIN ARE TO BE INSPECTED AND REPAIRED AS NEEDED, AND EXISTING PIPES TO BE CLEANED OUT TO REMOVE ALL SILT AND DEBRIS.
- 4. IF ANY EXISTING STRUCTURES TO REMAIN ARE DAMAGED DURING CONSTRUCTION IT SHALL BE THE CONTRACTOR'S RESPONSIBILITY TO REPAIR AND/OR REPLACE THE EXISTING STRUCTURE AS NECESSARY TO RETURN IT TO EXISTING CONDITIONS OR BETTER.
- CONTRACTOR SHALL ADJUST AND/OR CUT EXISTING PAVEMENT AS NECESSARY TO ENSURE A SMOOTH FIT AND CONTINUOUS GRADE.
- CONTRACTOR SHALL ENSURE POSITIVE DRAINAGE AWAY FROM BUILDINGS FOR ALL NATURAL AND PAVED AREAS.
- 7. THE CONTRACTOR SHALL COORDINATE WITH THE ARCHITECT FOR THE FINAL LOCATIONS OF PROPOSED ROOF DRAINS. LOCATIONS ARE SHOWN HEREON FOR COORDINATION PURPOSES ONLY.

- 8. WRITTEN DIMENSIONS ON THIS PLAN TAKE PRECEDENCE OVER SCALED DIMENSIONS. THE CONTRACTOR SHALL USE CAUTION WHEN SCALING REPRODUCED PLANS. IN THE EVENT OF A CONFLICT BETWEEN THIS PLAN SET AND ANY OTHER DRAWINGS AND/OR SPECIFICATIONS OR CONDITIONS, THE ENGINEER SHALL BE NOTIFIED BY THE CONTRACTOR.
- 9. ANY DAMAGE TO PRIVATE OR PUBLIC PROPERTIES DUE TO THE CONTRACTOR'S ACTIVITIES SHALL BE REPAIRED AND RESTORED BY THE CONTRACTOR AT THEIR OWN EXPENSE.
- 10. ALL PROPERTY MARKERS AND STREET LINE MONUMENTS SHALL BE PROPERLY PROTECTED DURING CONSTRUCTION. ANY DAMAGE TO THESE ITEMS SHALL BE REPAIRED AND RESTORED BY A LAND SURVEYOR LICENSED IN THE COMMONWEALTH OF MASSACHUSETTS AT THE CONTRACTOR'S EXPENSE.
- 11. THE CONTRACTOR IS RESPONSIBLE FOR OBTAINING ADDITIONAL BENCHMARK INFORMATION IF REQUIRED. THE CONTRACTOR IS RESPONSIBLE FOR LOCATING AND PROTECTING ALL EXISTING BENCHMARKS. IF IT IS NECESSARY TO RELOCATE A BENCHMARK, IT SHALL BE RELOCATED BY A LAND SURVEYOR AND DONE SO AT THE CONTRACTOR'S EXPENSE.
- 12. ALL PERMITS AND APPROVALS NECESSARY FROM AGENCIES GOVERNING THE WORK SHALL BE OBTAINED BY THE CONTRACTOR PRIOR TO THE COMMENCEMENT OF WORK.
- 13. CONSTRUCTION DURING WET WEATHER OR WINTER CONDITIONS IS TO BE ANTICIPATED AND PROVISIONS TO ADEQUATELY ADDRESS THESE CONDITIONS SHALL BE THE RESPONSIBILITY OF THE CONTRACTOR.
- 14. ALL CONSTRUCTION SHALL CONFORM TO THE APPLICABLE REGULATIONS AND STANDARDS INCLUDING THE CITY OF FRANKLIN, NHDOT, NHDES, MUTCD, AND AASHTO.

- 15. THE CONTRACTOR IS SOLELY RESPONSIBLE FOR THE MEANS AND METHODS OF CONSTRUCTION AND FOR CONDITIONS AT THE SITE. THESE PLANS, PREPARED BY ALLEN & MAJOR ASSOCIATES DO NOT EXTEND TO OR INCLUDE SYSTEMS PERTAINING TO THE SAFETY OF THE CONSTRUCTION CONTRACTOR OR THEIR EMPLOYEES, ACENTS OR CONSTRUCTION CONTRACTOR OR THEIR EMPLOYEES, AGENTS OR REPRESENTATIVES IN THE PERFORMANCE OF THE WORK, OR THE OWNER'S EMPLOYEES, CUSTOMERS, OR THE GENERAL PUBLIC. THE SEAL OF THE ENGINEER AS INCLUDED IN THE PLAN SET DOES NOT EXTEND TO ANY SUCH SAFETY SYSTEMS THAT MAY NOW OR HEREATER BE INCORPORATED INTO THESE PLANS. THE CONSTRUCTION CONTRACTOR SHALL PROVIDE THE APPROPRIATE SAFETY SYSTEMS WHICH MAY BE REQUIRED BY THE U.S. OCCUPATIONAL SAFETY AND HEALTH ADMINISTRATION (OSHA), STATE, AND LOCAL REGULATIONS.
- 16. THE INFORMATION SHOWN ON THIS PLAN IS THE SOLE PROPERTY OF ALLEN & MAJOR ASSOCIATES, INC. ITS INTENDED USE IS TO PROVIDE INFORMATION. ANY ALTERATION, MISUSE, OR RECALCULATION OF INFORMATION OR DATA WITHOUT THE EXPRESSED, WRITTEN CONSENT OF ALLEN & MAJOR ASSOCIATES, INC. IS STRICTLY PROHIBITED.

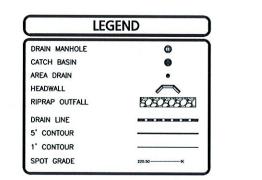

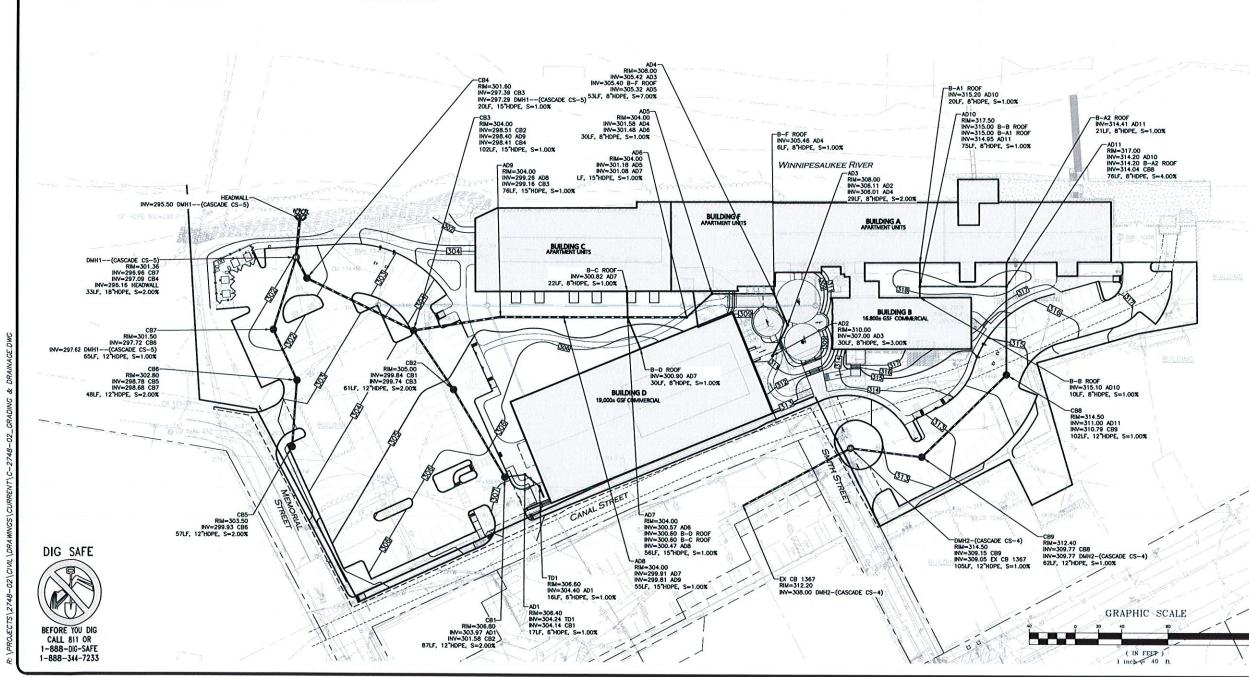

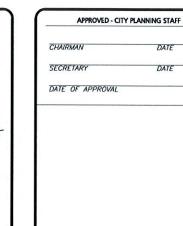



DATE

PROFESSIONAL ENGINEER FOR ALLEN & MAJOR ASSOCIATES, INC.

1	10-06-2020	ISSUED FOR SITE PLAN REVIE
REV	DATE	DESCRIPTION

PPLICANT\OWNER:

STEVENS MILL, LLC C/O CHINBURG PROPERTIES 3 PENSTOCK WAY **NEWMARKET, NH 03857** 

> STEVENS MILL REDEVELOPMENT 20 CANAL STREET FRANKLIN, NH 03235

PROJECT NO.	2748-02	DATE:	10-06-202
SCALE:	1" - 40'	DWG. NAME:	C2748-0
DESIGNED BY:	ARM	CHECKED BY:	ВС




ALLEN & MAJOR ASSOCIATES, INC.

civil engineering + land surveying vironmental consulting + landscape architectu www.allenmajor.com 400 HARVEY ROAD MANCHESTER, NH 03103 TEL: (603) 627-5500 FAX: (603) 627-5501

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GRADING & DRAINAGE PLAN | C-103

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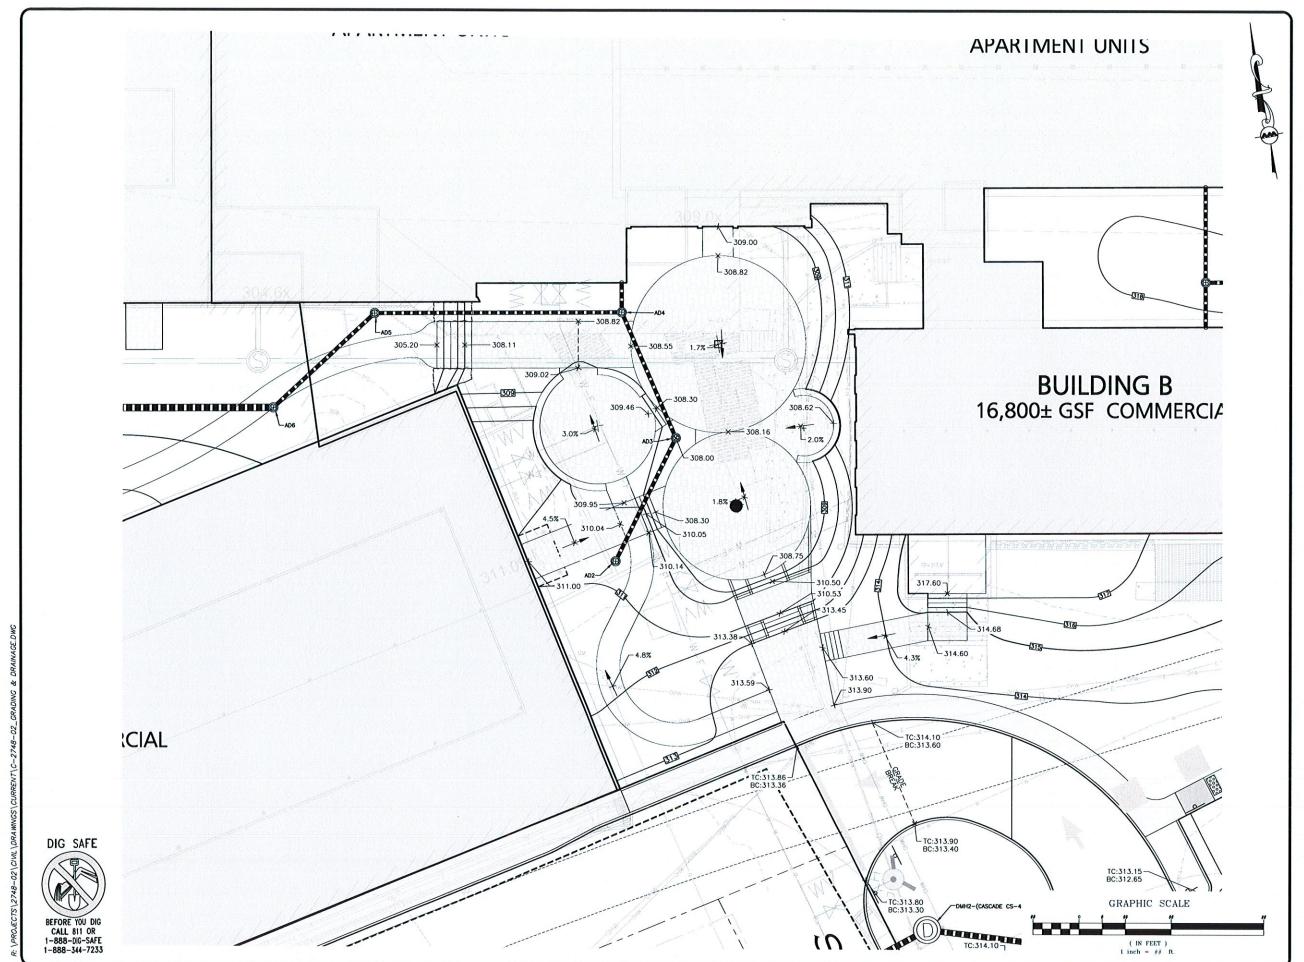
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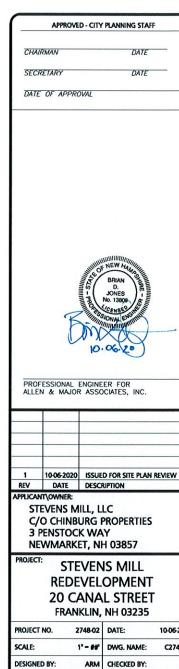
ASSOCIATES, INC. civil engineering + land surveying
nvironmental consulting + landscape architectu
www.allenmajor.com
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TEL: (603) 627-5500
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SPOT GRADE PLAN C-103A



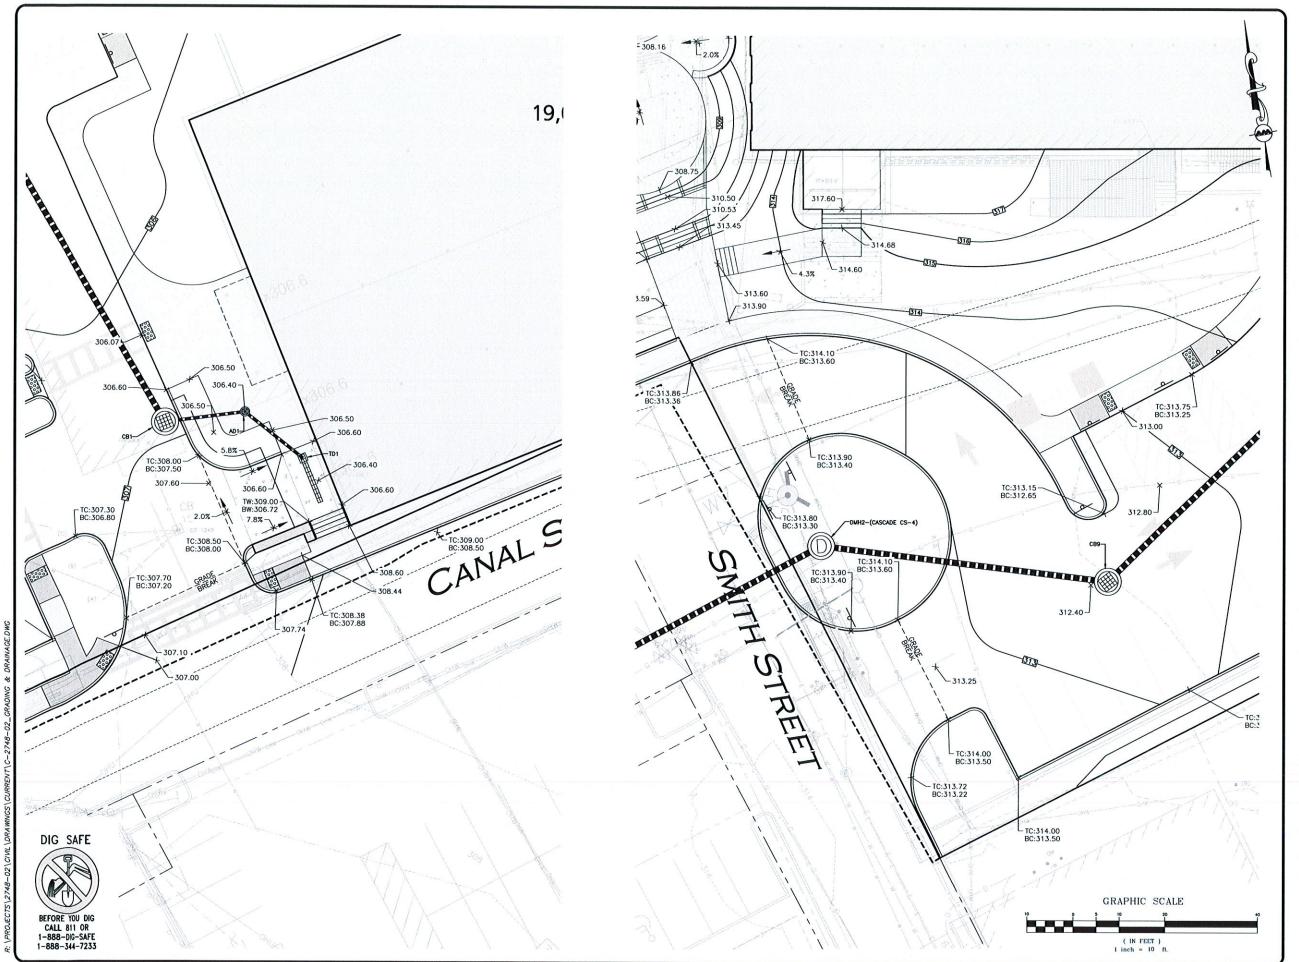


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MANCHESTER, NH 03103
TEL: (603) 627-5500
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C-103B

SPOT GRADE PLAN



1 10-06-2020 ISSUED FOR SITE PLAN REVIEW REV DATE DESCRIPTION STEVENS MILL, LLC C/O CHINBURG PROPERTIES **3 PENSTOCK WAY** NEWMARKET, NH 03857 STEVENS MILL REDEVELOPMENT

APPROVED - CITY PLANNING STAFF

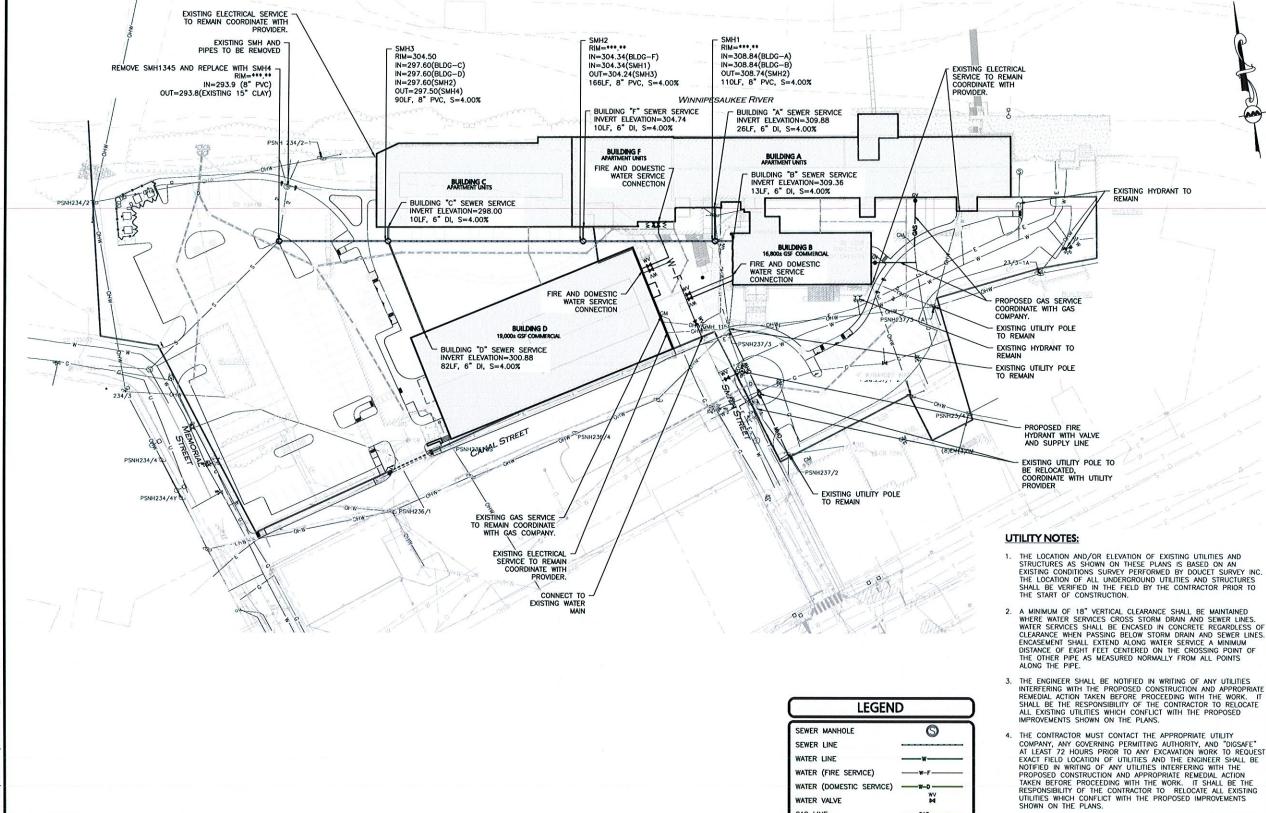DATE

DATE

CHAIRMAN

SECRETARY

DATE OF APPROVAL

DESIGNED BY: ARM CHECKED BY:

**20 CANAL STREET** 

FRANKLIN, NH 03235

2748-02 DATE:

1" = 40' DWG. NAME:

ALLEN & MAJOR ASSOCIATES, INC.

civil engineering a land surveying ronmental consulting a landscape architectu w w . a l l e n m a j o r . c o m 400 HARVEY ROAD MANCHESTER, NH 03103 TEL: (603) 627-5500 FAX: (603) 627-5501

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DRAWING TITLE:

PROJECT NO.

SCALE:

SHEFT No. C-104

10-06-202

C2748-0

**UTILITIES PLAN** 

( IN FEET )

DIG SAFE





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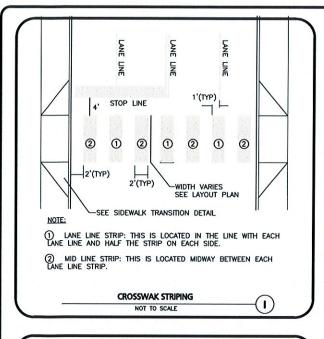
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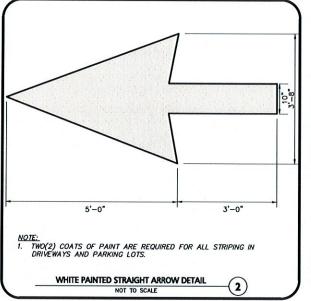
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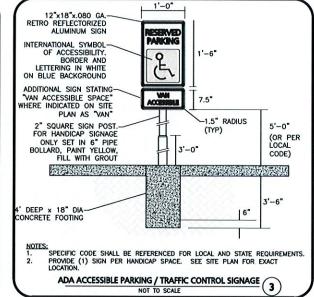
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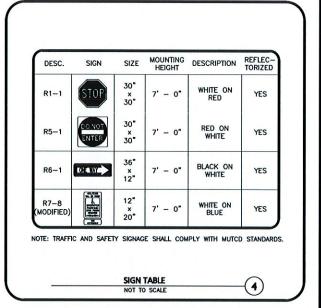
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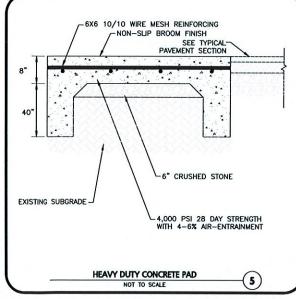
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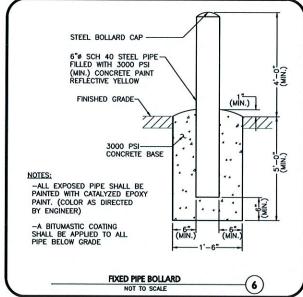










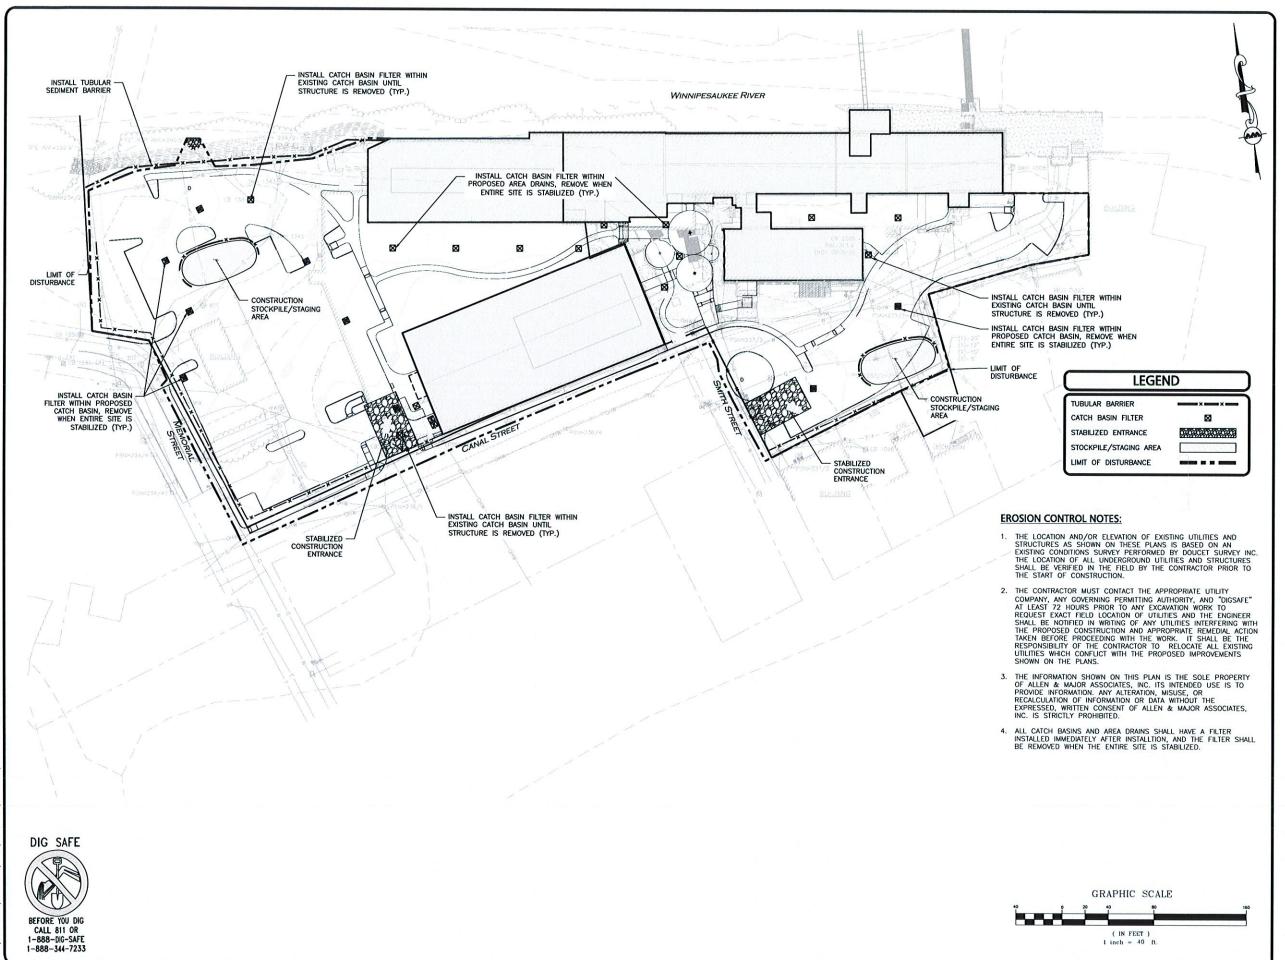


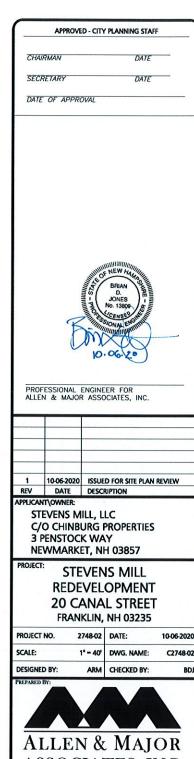

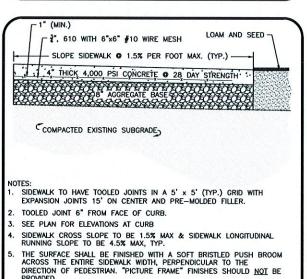

NOT TO SCALE

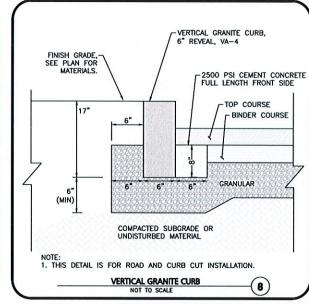


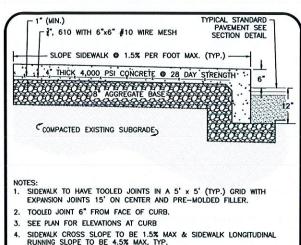


MONOLITHIC CONCRETE SIDEWALK


WITH 6" REVEAL NOT TO SCALE

(9)

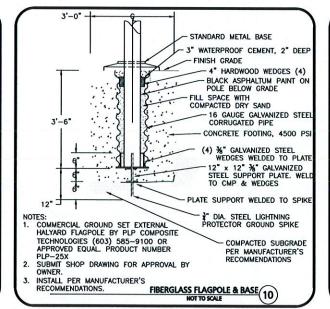

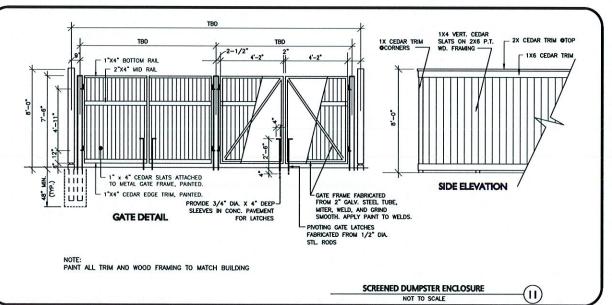

(7)

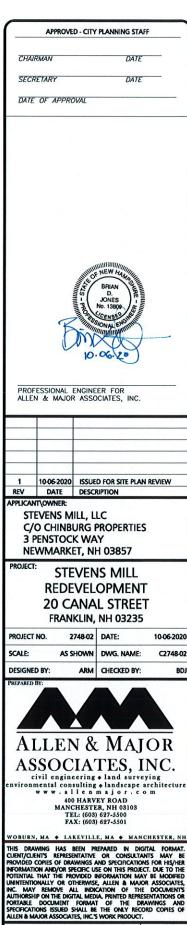



**DETAILS** 

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C-501

THE SURFACE SHALL BE FINISHED WITH A SOFT BRISTLED PUSH BROOM ACROSS THE ENTIRE SIDEWALK WIDTH, PERPENDICULAR TO THE DIRECTION OF PEDESTRIAN. "PICTURE FRAME" FINISHES SHOULD NOT BE



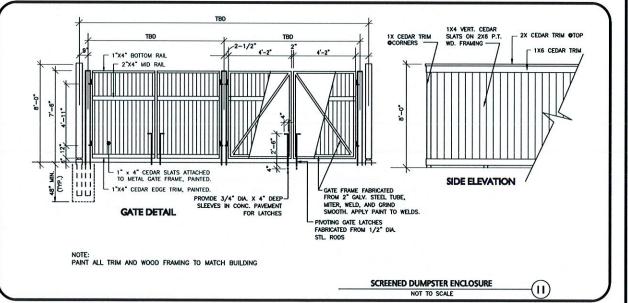

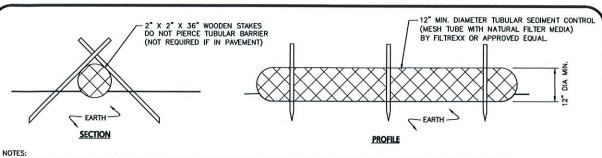TUBULAR SEDIMENT CONTROL SHALL BE 12" MIN. DIAMETER MESH TUBE WITH NATURAL FILTER MEDIA BY FILTREXX OR APPROVED EQUAL.


- 2. ALL MATERIALS TO MEET MANUFACTURERS SPECIFICATIONS.
- INSTALL WOODEN STAKES IN A CRISS-CROSS PATTERN EVERY 8' ON CENTER
- OVERLAP TUBULAR BARRIER SEGMENTS A MINIMUM OF 12"


OWNE OF SEDIMENT ONTO PUBLIC

SEDIMENT TRAP OR SEDIMENT BASIN.

- THE CONTRACTOR SHALL MAINTAIN THE TUBULAR BARRIERS IN A FUNCTIONAL CONDITION AT ALL TIMES. THE CONTROLS SHALL BE ROUTINELY
- WHERE THE TUBULAR BARRIERS REQUIRE REPAIR OR SEDIMENT REMOVAL, IT WILL BE COMPLETED BY THE CONTRACTOR AT NO ADDITIONAL COST.
- 7. AT A MINIMUM, THE CONTRACTOR SHALL REMOVE SEDIMENTS COLLECTED AT THE BASE WHEN THEY REACH 1/3 THE EXPOSED HEIGHT OF THE BARRIER.



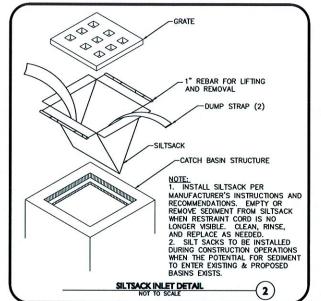

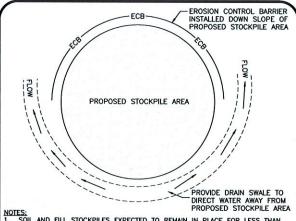

NOTES:

1. SOIL AND FILL STOCKPILES EXPECTED TO REMAIN IN PLACE FOR LESS THAN 90 DAYS SHALL BE COVERED WITH STRAW AND MULCH (AT 100LBS/1,000 SF), OR WITH AN ANCHORED TARP WITHIN 7 DAYS OR PRIOR TO ANY RAINFALL.

2. SOIL AND FILL STOCKPILES EXPECTED TO REMAIN IN PLACE FOR 90 DAYS OR MORE SHALL BE SEEDED WITH WINTER RYE (FOR FALL SEEDING AT 1LB/1,000 SF) OR OATS (FOR SUMMER SEEDING AT 2LB/1,000 SF) AND THEN COVERED WITH
STRAW MULCH (AT 100LB/1,000 SF) OR AN ANCHORED TARP WITHIN 7 DAYS OR
PRIOR TO ANY RAINFALL.

STOCKPILE PROTECTION DETAIL

NOT TO SCALE

GENERAL NOTES

1. CONTECH TO PROVIDE ALL MATERIALS UNLESS NOTED OTHERWISE.

2. CASCADE SEPARATOR STRUCTURE SHALL MEET AASHTO HS20 LOAD RATING, ASSUMING EARTH COVER OF O' - 2' [610]. AND GROUNDWATER ELEVATION AT, OR BELOW, THE OUTLET PIPE INVERT ELEVATION. CASTINGS SHALL MEET AASHTO M306 AND BE CAST WITH THE CONTECH LOGO.

3. CASCADE SEPARATOR STRUCTURE SHALL BE PRECAST CONCRETE CONFORMING TO ASTM C478 AND AASHTO LOAD FACTOR DESIGN METHOD. INSTALLATION NOTES.

PIPE(S). MATCH PIPE INVERTS WITH ELEVATIONS SHOWN ON PLAN. ALL PIPE CENTERLINES TO MATCH PIPE OPENING CENTERLINES. CONTRACTOR TO TAKE APPROPRIATE MEASURES TO ASSURE UNIT IS WATER TIGHT, HOLDING WATER TO FLOWLINE INVERT MINIMUM. ALL JOINTS BELOW PIPE INVERTS ARE TO BE GROUTED.

TOP SLAB ACCESS

(SEE FRAME AND

COVER DETAIL)

FLOW

ELEVATION A-A

WATER QUALITY INLETS

NOT TO SCALE

FRAME AND COVER

OUTLE PIPE

(8)

INSTALLATION NOTES

A CONTRACTOR TO INSTALL JOINT SEALANT BETWEEN ALL STRUCTURE SECTIONS AND ASSEMBLE STRUCTURE.

B. CONTRACTOR TO PROVIDE, INSTALL, AND GROUT INLET AND OUTLET OF THE PROVIDE OF THE PRO

INLET PIPE(S)

LOCATION MAY

WITHIN 260"

CONTRACTOR TO GROUT-TO FINISHED GRADE

TOP OF CENTER CHAMBER (EXTENSIONS AVAILABLE

INLET PIPE—
(MULTIPLE INLET PIPES

FIRERGIASS OR ALLIMINUM

CASCADE

CONTECH

separator DETAILS PROVIDED BY: PLAN VIEW

GRADE

RINGS/RISERS

AS REQUIRED)

ELEVATION

SOLIDS: STORAGE SUMP



APPROVED - CITY PLANNING STAFF

DATE

SECRETARY

DATE OF APPROVAL

PROFESSIONAL ENGINEER FOR

1 10-06-2020 ISSUED FOR SITE PLAN REVIEW
REV DATE DESCRIPTION

PPLICANT\OWNER:

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STEVENS MILL REDEVELOPMENT **20 CANAL STREET** FRANKLIN, NH 03235

ROJECT NO. 2748-02 DATE: 10-06-202 SCALE: AS SHOWN DWG. NAME: C2748-0 DESIGNED BY ARM CHECKED BY




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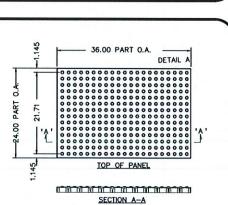
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NYLOPLAST GRATE NYLOPLAST INLINE-DRAINAGE STRUCTURE OR EQUAL LANDSCAPE AREA FINISH GRADE 12" MIN. COVER PIPE PER ON PLAN VIEW PIPE PER ON PLAN MEW SHALL BE CRUSHED STONE OR GRAVEL MATERIAL MEETING CLASS 1 OR 2 AS SPECIFIED IN ASTM D2321 AREA DRAIN DETAIL (5)







(6)

PROPOSED BASE COURSE PROPOSED GRAVEL COURSE Y EXISTING GRAVEL COURS SEE STANDARD PAVEMENT DETAIL 12" MIN PAVEMENT KEY CUT DETAIL

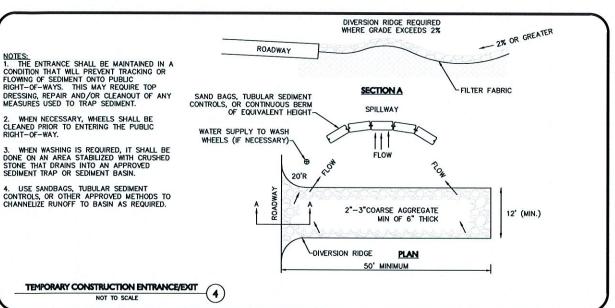
WATER TO ONE ONE PART ASPHALT FOLLOWING AASHTO M140/ASTM D997, OR AASHTO M208/ASTM D2397, SS-1H, CSS-1, OR CSS-1H. CLEAN JOINT OF ALL DEBRIS AND PROVIDE TACK COAT SAW CUT EDGES EXISTING TOP COURSE PROPOSED TOP COURSE


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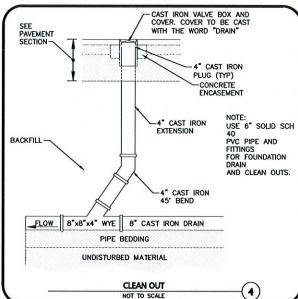
NOTE:
THE MANHOLE, INCLUDING ALL COMPONENT PARTS, SHALL HAVE ADEQUATE SPACE, STRENGTH AND LEAK PROOF QUALITIES CONSIDERED NECESSARY FOR THE INTENDED SERVICE SPACE REQUIREMENT AND CONFIGURATIONS SHALL BE AS SHOWN ON THE DRAWING, MANHOLES MAY BE AN ASSEMBLY OR PRECAST SECTIONS, WITH ON WITHOUT STEEL REINFORCEMENT, WITH ADEQUATE JOINTING OR CONCRETE CAST MONOLITHICALLY IN PLACE WITH OR WITHOUT REINFORCEMENT, IN ANY APPROVED MANHOLE, THE COMPLETE STRUCTURE SHALL BE OF SUCH MATERIAL AND QUALITY AS TO WITHSTAND LOADS OF 8 TONS (H-20 LOADING) WITHOUT FAILURE AND PREVENT LEAKAGE IN EXCESS OF ONE GALLON PER DAY PER VERTICAL FOOT OF MANHOLE.

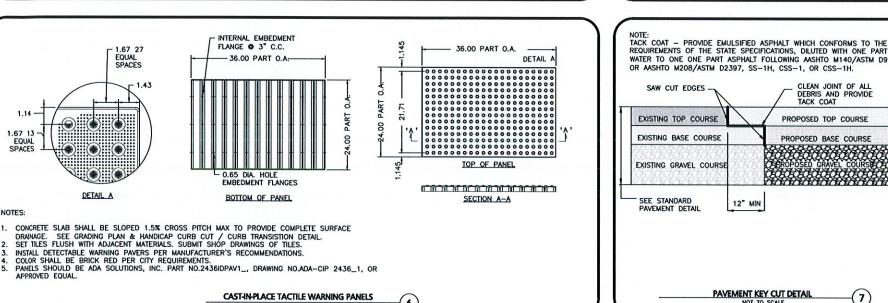


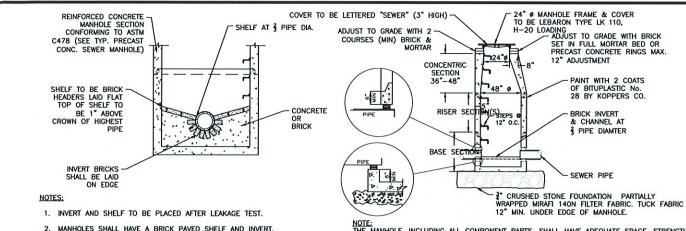

CONSTRUCTED TO CONFORM TO THE SIZE OF PIPE AND FLOW. AT CHANGES IN DIRECTION, THE INVERTS SHALL BE LAID OUT IN CURVES OF THE LONGEST RADIUS POSSIBLE TANGENT TO THE CENTER LINE OF THE HIGHEST PIPE CROWN AND SLOPE TO DRAIN TOWARD THE

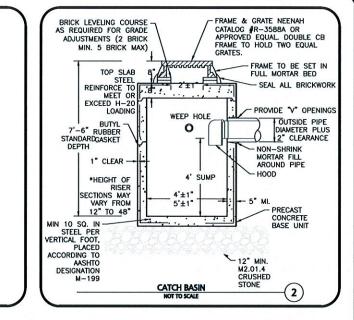FLOWING THROUGH CHANNEL. UNDERLAYMENT OF INVERT AND SHELF SHALL CONSIST OF CEMENT CONCRETE OR BRICK IN MORTAL

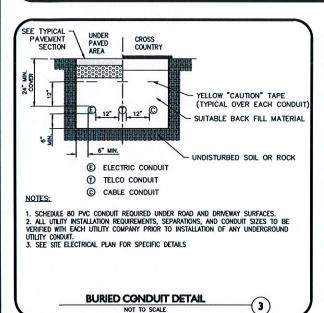


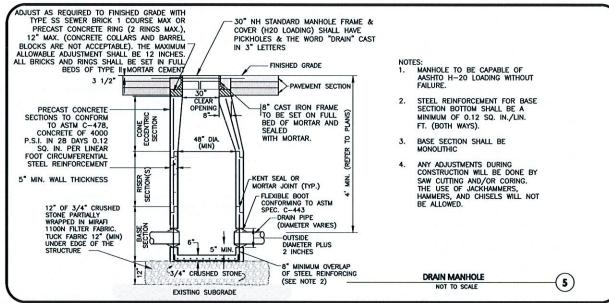

### NOTES:

WHENEVER CONDITIONS PREVENT A LATERAL SEPARATION OF 10 FEET BETWEEN A SEWER MAIN AND A WATER/DRAIN MAIN:


- THE WATER/DRAIN MAIN SHALL BE LAID IN A SEPARATE TRENCH AND THE DIFFERENCE IN ELEVATION BETWEEN THE WATER/DRAIN MAIN AND THE SEWER MAIN SHALL BE AT LEAST 18 INCHES.
- 2. THE PIPE CROSSING SHALL OCCUR AS CLOSE TO 90° AS PRACTICABLE.
- 3. THE PIPE JOINTS SHALL BE STAGGERED TO PROVIDE THE MAXIMUM SEPARATION FROM THE POINT OF CROSSING.
- THE CROSSING SHALL BE ENCASED IN CONCRETE FOR THE ENTIRE WIDTH OF THE TRENCH AND FOR A DISTANCE OF 10 LINEAR FEET CENTERED ON THE CROSSING.
- 5. UTILITIES A AND B CAN BE EITHER NEW OR EXISTING.
- 6. WHEN ONE UTILITY IS A SANITARY SEWER. IT IS PREFERABLE TO BE POSITIONED AS SHOWN FOR UTILITY B.
- 7. ENCASEMENT EXTENDS 10'-0" ON EACH SIDE OF THE CENTERLINE OF
- PIPE MUST BE BRACED VERTICALLY AND HORIZONTALLY TO PREVENT FLOATATION DURING PLACEMENT OF CONCRETE.

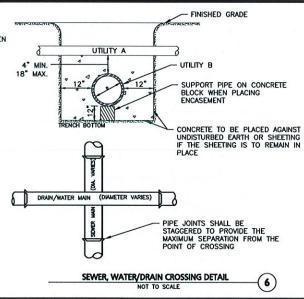

LAYER NUMBER	LAYER DESCRIPTION	LAYER THICKNESS (INCHES)
1	BITUMINOUS WEARING COURSE (J. AGGREGATE - NHOOT PRE-APPROVED MIX DESIGN)	1.5"
2	BITUMINOUS BINDER COURSE (3" AGGREGATE - NHOOT PRE-APPROVED MIX DESIGN)	1.5*
3	CRUSHED GRAVEL (BASE COURSE) (NHDOT ITEM 304.3)	6.0
4	GRAVEL BORROW (SUBBASE COURSE) (NHDOT ITEM 304.2)	12"
5	CLEAN GRANULAR FILL MATERIAL OR APPROVED ON-SITE MATERIALS (SUBGRADE)	AS NECESSARY

PRECAST CONCRETE SEWER MANHOLE
NOT TO SCALE

	PERCENT PASSING BY WEIGHT			
SIEVE	CLEAN GRANULAR FILL	BASE COURSE	SELECT GRANULAR FILL	
8*	100	100	100	
3"	70-100	100	70-100	
1.	40-100	40-80	40-90	
No. 4	25-100	30-70	25-80	
No. 10	15-95	20-60	15-70	
No. 40	10-70	10-30	5-40	
No. 200	0-15	3-10	0-12	

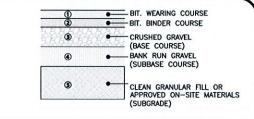

NOTES:

- IF A GEOTECHNICAL REPORT IS PREPARED THE RECOMMENDATIONS WITHIN THAT REPORT SHALL SUPERCEDE RECOMMENDATIONS HEREIN. THE CONTRACTOR SHALL HAVE AND REVIEW A COPY OF THE GEOTECHNICAL REPORT AND COMPLY WITH THE RECOMMENDATIONS THEREIN.
- TOPSOIL SHALL BE REMOVED BENEATH ALL PAVEMENT AREAS TO EXPOSE THE NATURALLY—OCCURRING SOILS OR ACCEPTABLE ON—SITE FILL MATERIALS.
- THE SUBGRADE SHOULD BE PROOFROLLED UNDER THE SUPERVISION OF A GEOTECHNICAL ENGINEER USING AT LEAST 4 PASSES OF A 10-TON VIBRATORY ROLLER. AREAS OF THE SUBGRADE THAT "WEAVE" OR "ROLL" EXCESSIVELY SHOULD BE OVEREXCAVATED AND REPLACED WITH DRIER CLEAN GRANULAR FILL MATERIAL.
- THE PAVEMENT SUBGRADE CONSISTING OF THE SPECIFIED CLEAN GRANULAR FILL SHALL BE PLACED IN 12" MAXIMUM LIFTS AND COMPACTED TO A DRY DENSITY OF AT LEAST 95 PERCENT OF THE MATERIALS MAXIMUM DRY DENSITY AS DETERMINED BY ASTM DESIGNATION D-1557.

PAVEMENT SECTIONS	7
NOT TO SCALE	(/

APPROVED - CITY PLANNING STAFF SECRETARY DATE DATE OF APPROVAL PROFESSIONAL ENGINEER FOR 1 10-06-2020 ISSUED FOR SITE PLAN REVIEW
REV DATE DESCRIPTION PPLICANT\OWNER: STEVENS MILL, LLC C/O CHINBURG PROPERTIES 3 PENSTOCK WAY **NEWMARKET, NH 03857** STEVENS MILL REDEVELOPMENT **20 CANAL STREET** FRANKLIN, NH 03235 ROJECT NO. 2748-02 DATE: SCALE: AS SHOWN DWG. NAME: DESIGNED BY: ARM CHECKED BY:

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ASSOCIATES, INC. civil engineering + land surveying vironmental consulting + landscape architects www.allenmajor.com

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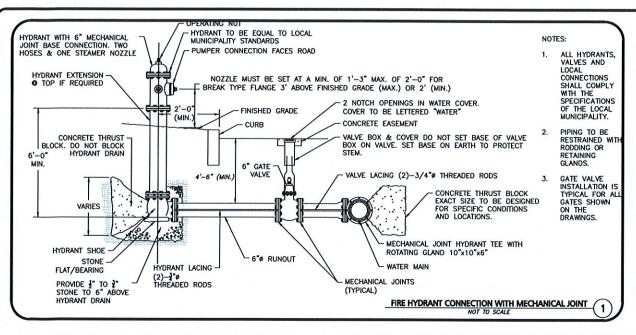
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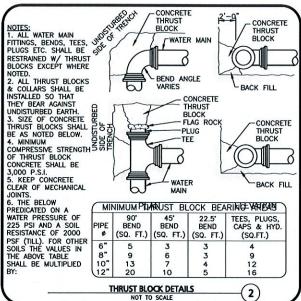
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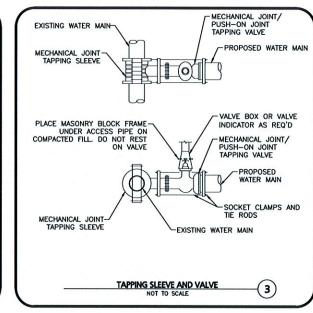
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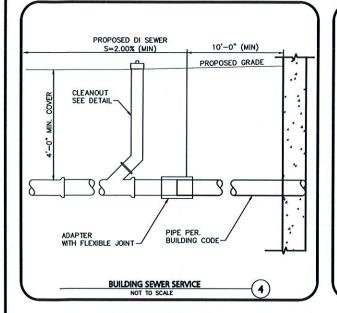
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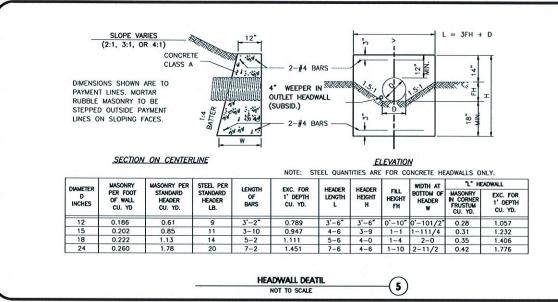
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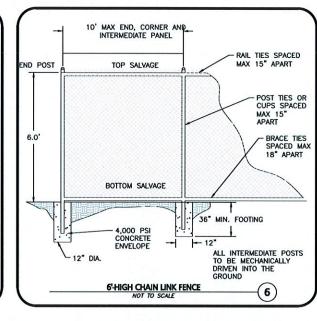















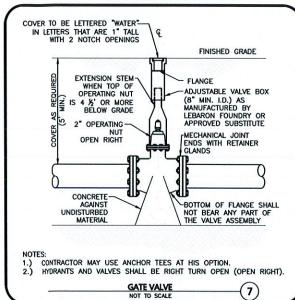

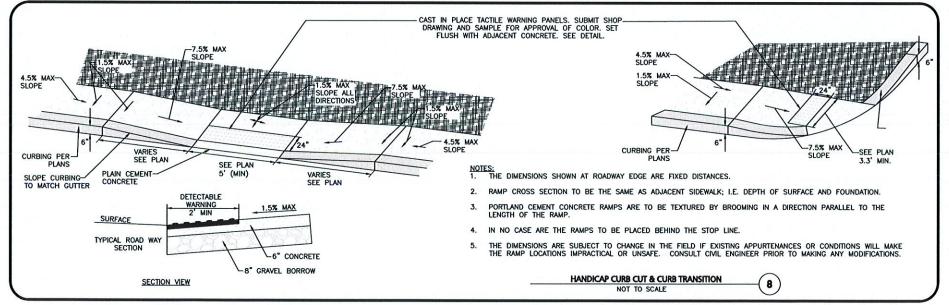

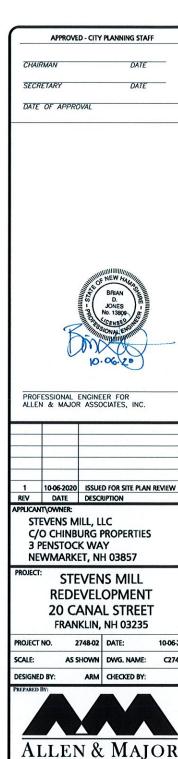

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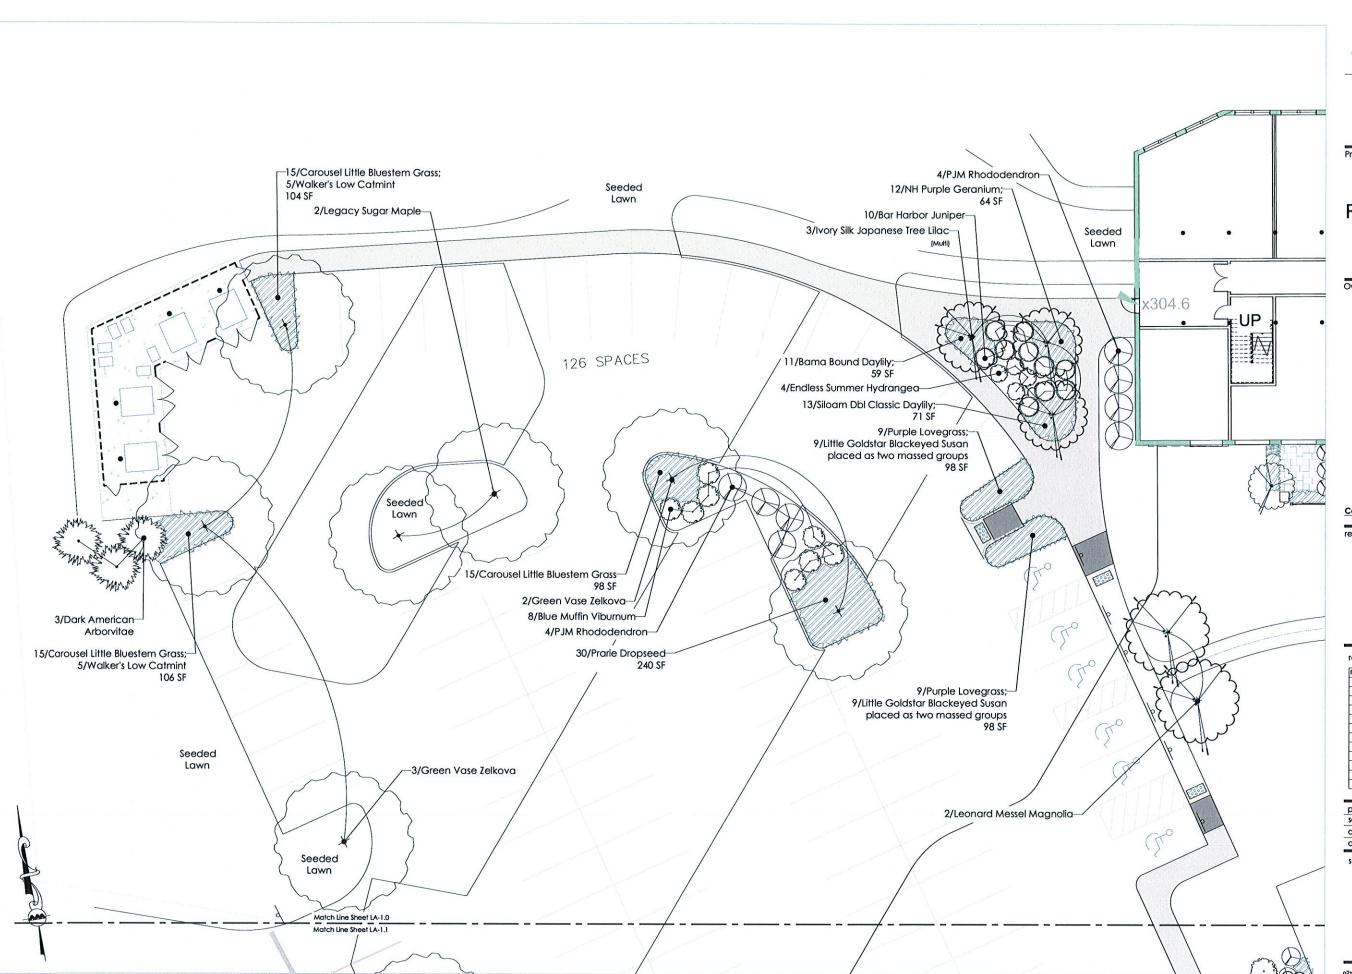
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Project Name:

### Stevens Mill Redevelopment

20 Canal Street Franklin NH 03235

Owner/Applicant:

Chinburg Properties

3 Penstock Way Newmarket, New Hampshire 03857

Conceptual, Issued for Review

registration:




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Landscape Plan

LA-1.0



g2+1 ccc itecture Site Manning Grap

70 New Road Salisbury, NH 03268 tel: 603.648.6434 web: www.g2plus1.com

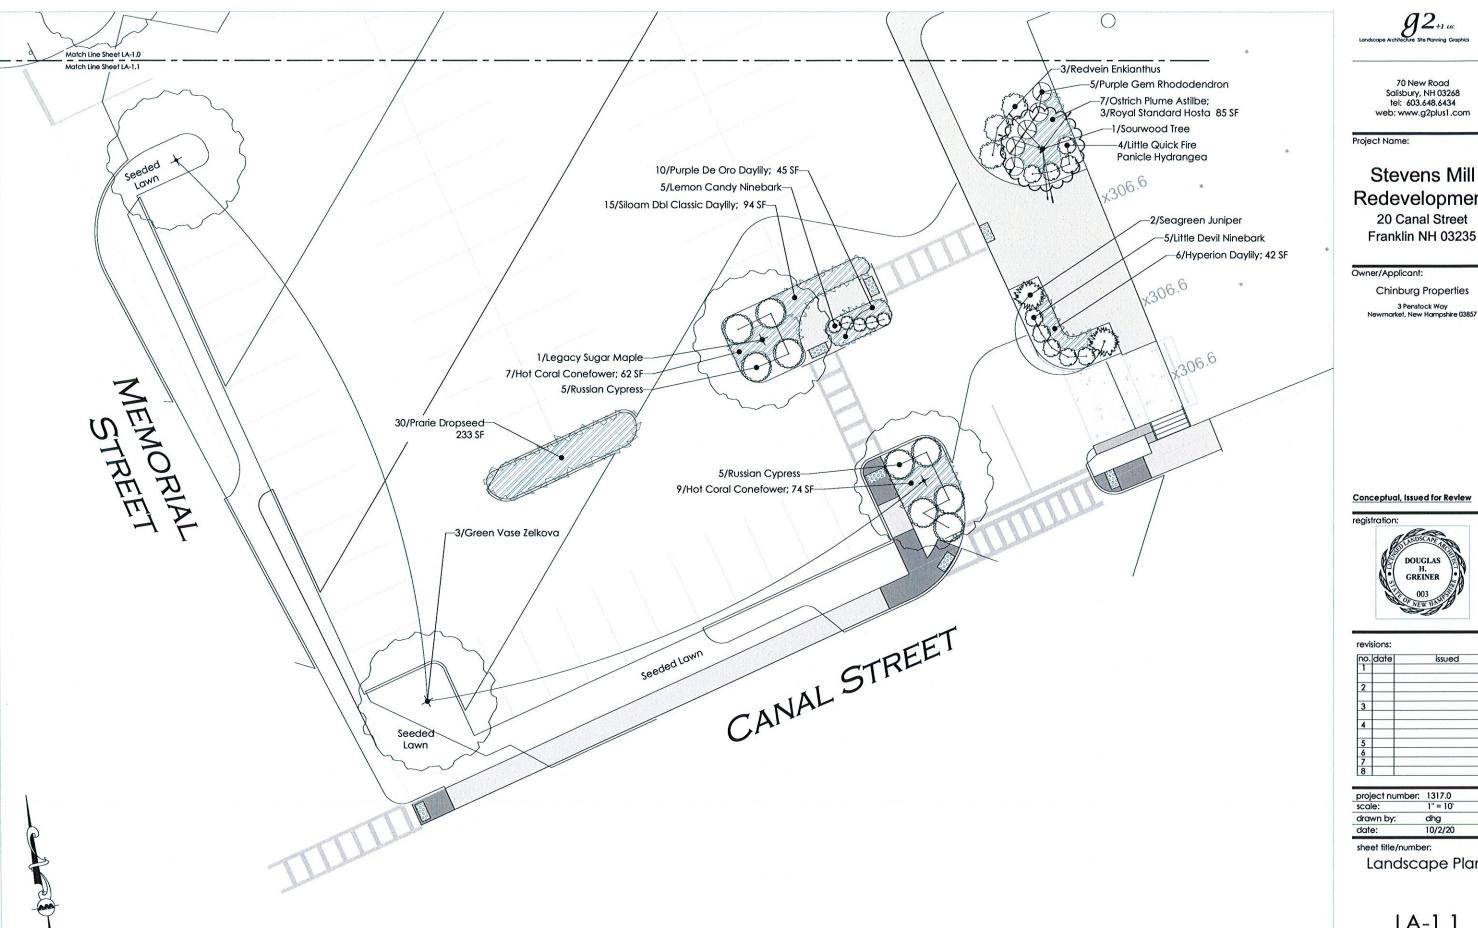Project Name:

### Stevens Mill Redevelopment 20 Canal Street

Owner/Applicant:

**Chinburg Properties** 

3 Penstock Way Newmarket, New Hampshire 03857

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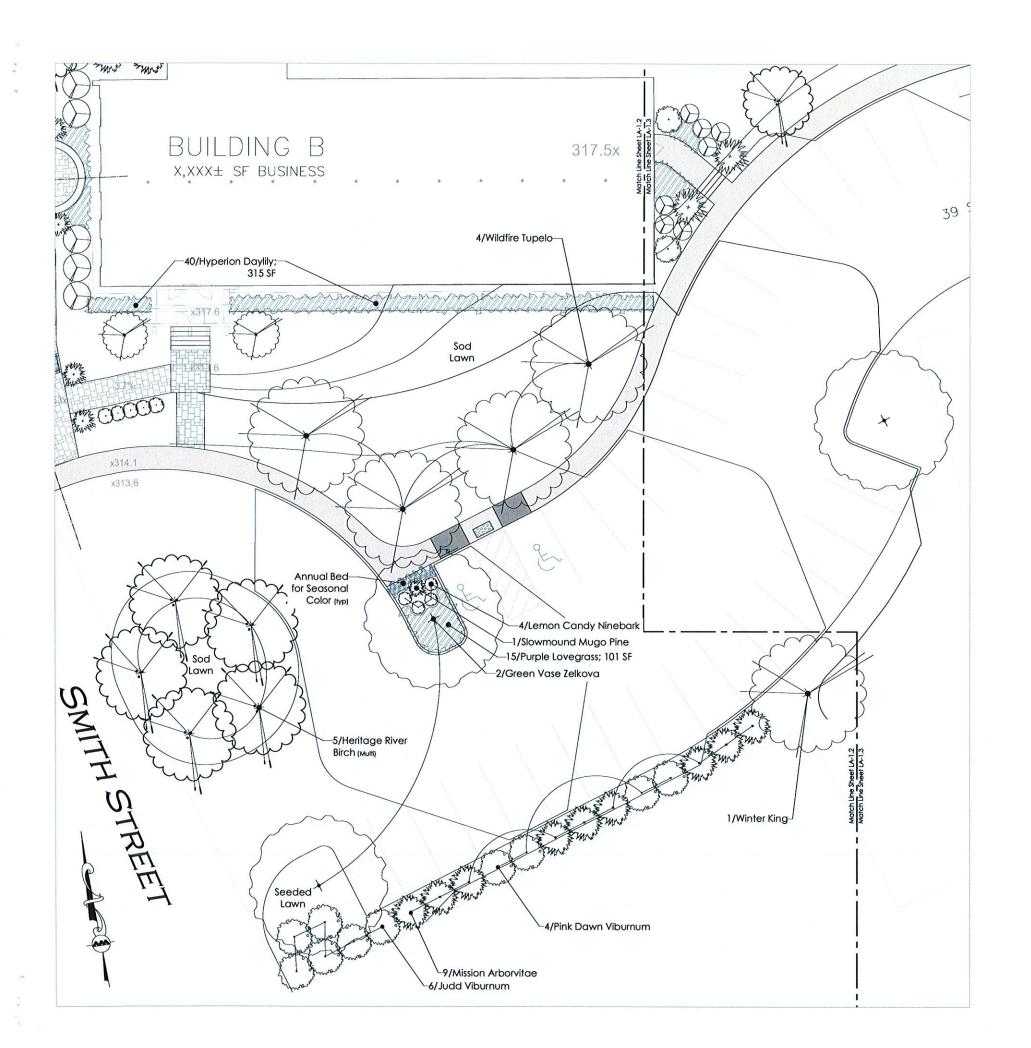


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LA-1.1





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# Stevens Mill Redevelopment

20 Canal Street Franklin NH 03235


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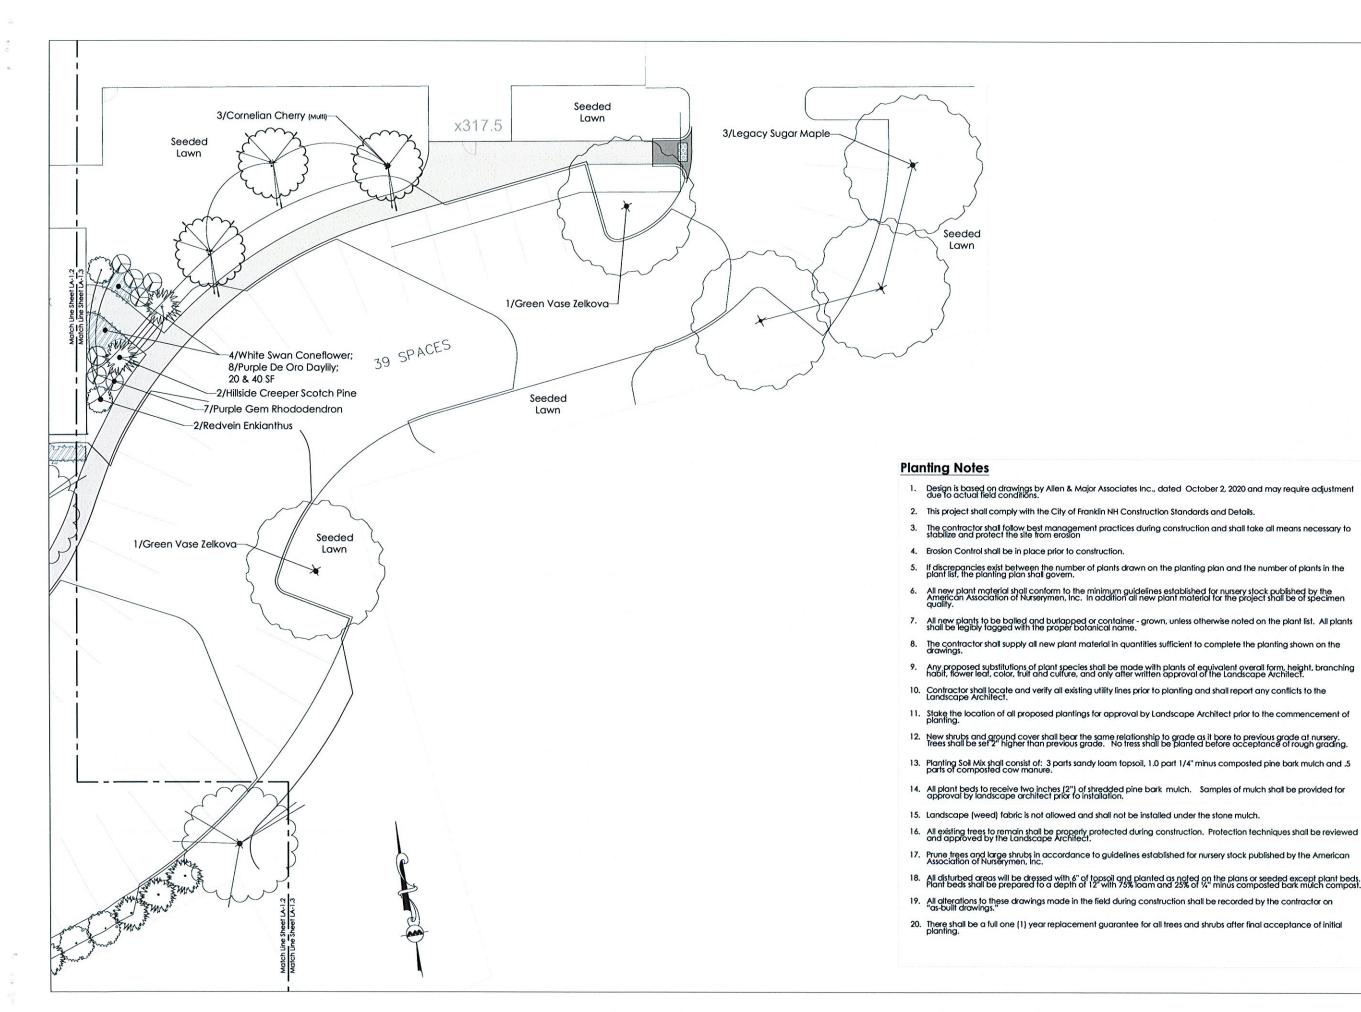
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Landscape Plan

LA-1.2





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Project Name:
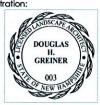
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20 Canal Street Franklin NH 03235

Owner/Applicant:

**Chinburg Properties** 

3 Penstock Way Newmarket, New Hampshire 03857

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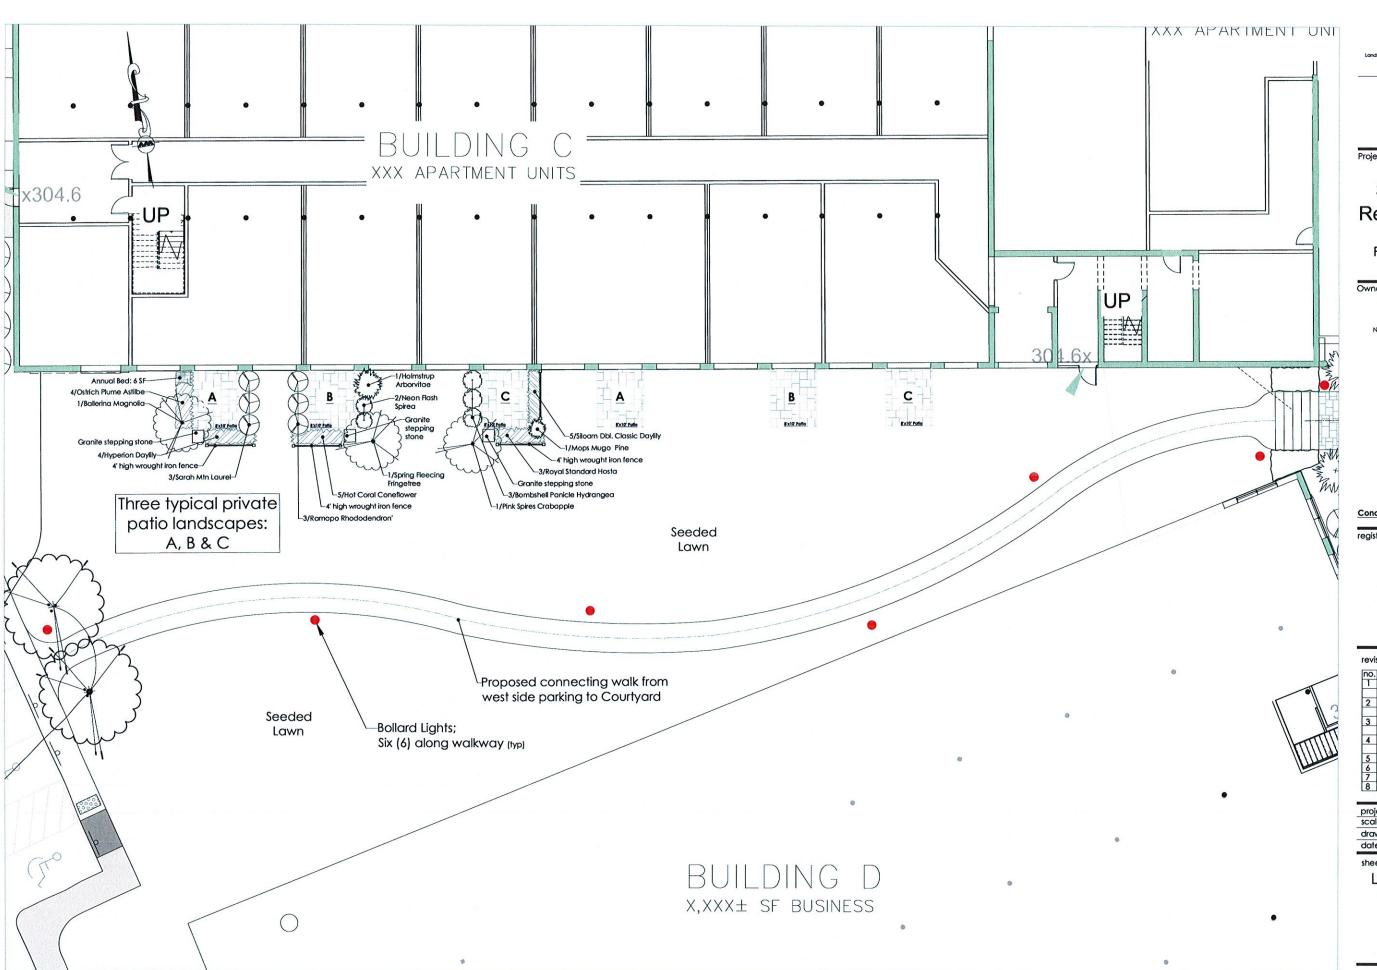
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Landscape Plan & Planting Notes

LA-1.3



g2+1 LLC

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Project Name:

### Stevens Mill Redevelopment

20 Canal Street Franklin NH 03235

### Owner/Applicant:

**Chinburg Properties** 3 Penstock Way wmarket, New Hampshire 03857

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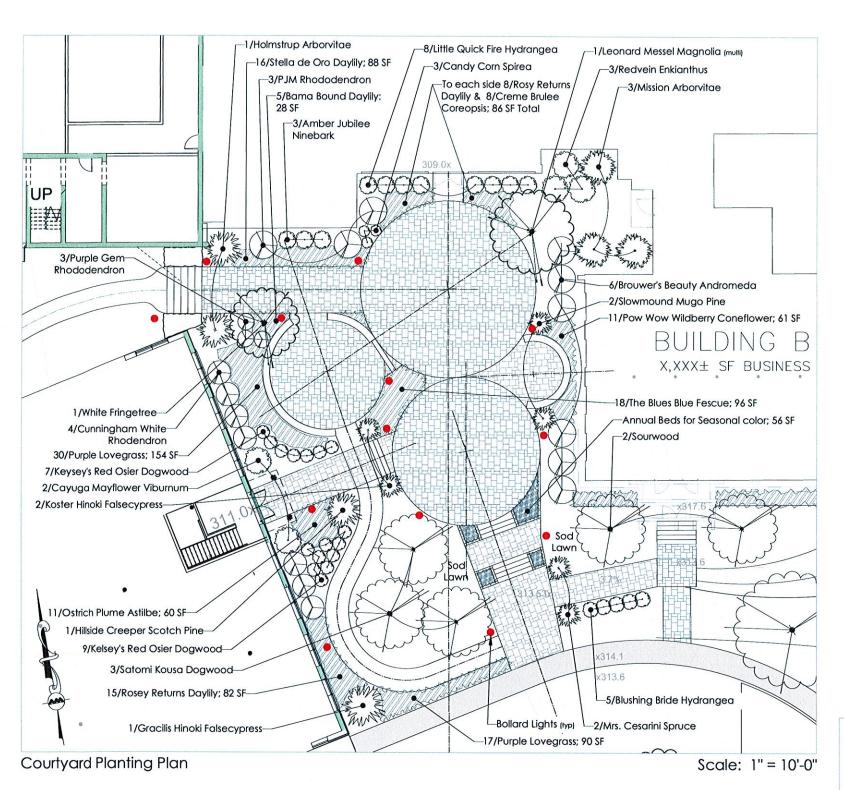
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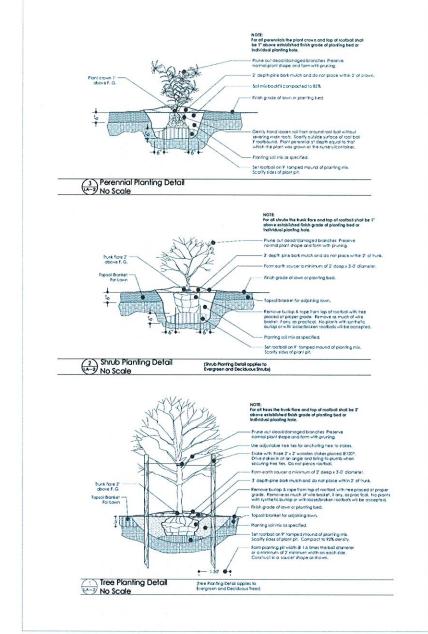
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Landscape Plan Private Patios

LA-1.4





### Typical Planting Details

Patio Pavement Section Detail



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Project Name:

# Stevens Mill Redevelopment 20 Canal Street

Franklin NH 03235

Owner/Applicant:

**Chinburg Properties** 

3 Penstock Way Newmarket, New Hampshire 03857

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Courtyard Landscape Plan & Construction Details

LA-2.0

**Plant Schedule** Stevens Mill Redevelopment

Large, Deciduous Trees

HRB.M 6 Heritage River Birch - MULTI
LSM 7 Legacy Sugar Maple
GVZ 12 Green Vase Zelkova
TUP 4 Wildfire Tupelo

Small, Accent Flowering Trees

Sym Qty Common Name

Overall Plantings Sheets LA-1.0, 1.1, 1.2 & 1.3

Betula nigra 'heritage'

Acer saccharinum 'legacy'

Zelkova serrata 'green vase

Nyssa sylvatica 'wildfire'

Habit of Growth

40-70' 20-30' 10'

Zone Height Spread Installed Size Type Notes

ht. B&B

30-40' 20-30' 2-1/2" cal. | B&B | native, full sun & shade

4 60' 40-60' 2-1/2" cal. B&B Good street tree, tolerates poor soil conditions

3 50-60' 35-40' 2-2-1/2" cal. B&B hardy, vigorous

10/2/2020

Private Patio Plantings Sheet LA-1.4

10/2/2020

**Plant Schedule** Stevens Mill Redevelopment

Sym Qty Common Name **Botanical Name** Patio A (Plants for two patios) BLM 2 Ballerina Magnolia MTL.4 6 Sarah Hybrid Mountain Laurel gnolia loebneri 'ballerina 15-20' 8-10' (almia latifolia 'sarah' 4 3-1/2' 3-1/2' 5 gal. CTN Small Accent GC.A-3 GC.L-3 8 Daylily 8 Astilbe Hemerocallis Hyperion 1 yr. potted 1 gal. 40", s/PSh, June/Aug. Sulfur Yellow Astilbe 'ostrich plume' yr. potted 2 qt 24-30°, PSh/Sh, June, Dark Foliage w/ Salmon Pie Patio B (Plants for two patios) SFF 2 Spring Fleecing Fringetree RPR 6 Ramapo Rhododendron 4 10-15' 10-15' 2-1/2" cal. 8&B Prolific white blooms, glossy foliage
4 2-3' 3-4' 5 gal. CTN Lavender flower, green to bronze foliage
2 10' 3-4' 3'-4' ht. 8&B columnar, shade tolerant chionanthus virginicus 'spring fleecing' Rhododendron 'ramapo' 2 Holmstrup Arborvitae 4 Neon Flash Spirea 10 Hot Coral Coneflower HLMS NEFS Thuja occidentalis 'holmstrup' Spirea japonica 'neon flash' gal. CTN Compact facer GC.C-2 1 chinacea purpurea 'hot coral' 1 yr. potted 1 gal. 22", S, June/Aug, Hot Coral Pint Patio C (Plants for two patios) 2 15-20' 8'-10' 2-1/2" cal. 8&B Narrow, upright form, red tinted foliage
3 3-4' 3-4' 3 gal. CTN sun, compact form, winter hardy
2 2-3' 2-3' 6 gal. CTN Low, compact dense form
1 yr. potted 1 yr. potted 1 gal. 24-28', XNN, Aug/Sept, White flower, Rich Grin leaf PSC 2 Pink Spires Crabapple
FLH-3 6 Bombshell Panicle Hydrangea
MPS 2 Mops Mugo Pine
GC.A-9 10 Daylily
GC.H-5 6 Hosta Malus 'pink spires' Hydrangea paniculata 'bombshell Pinus mugo 'mops' Hemerocallis flava 'Siloam Dbl. Classic' Hosta 'Royal Standard'

Private Patios Plant Schedule

**Plant Schedule** 

**Courtyard Plantings Sheet LA-2.0** 

10/2/2020

Stevens Mill Redevelopme

Sym	To-	Common Name	Botanical Name	15		Growth		-	1
	-	ccent Flowering Trees	Botanical Name	Zone	Height	Spread	Installed Size	Туре	Notes
									STATE OF THE PROPERTY OF THE P
KD LMM	1	Satomi Kousa Dogwood	Cornus kousa 'satomi'	5	15-20'	10-15'	7'-8' ht.	B&B	Reddish purple fall foliage, exfoliating bark
WFT	1 5		Magnolia loebneri 'leonard messel'	4	15-20'	10-15'	8'-10' ht.	B&B	Vigorous/hardy, star like petals
STC		White Fringetree - MULTI	Chionanthus virginicus	3	15-20'	15-20'	7'-8' ht.	B&B	Fragrant Flowers, Small berries loved by birds
SIC	ľ	Sugar Tyme Crabapple	Malus 'sugar tyme'	4	18'	10-15'	2-1/2" cal.	B&B	Upright oval
Everg	ree	en Trees & Accent Everg	reens					8	
HLMS	1	Holmstrup Arborvitae	Thuja occidentalis 'holmstrup'	2	10'	3-4'	3'-4' ht.	B&B	columnar, shade tolerant
MSA	3	Mission Arborvitae	Thuja occidentalis 'techney'	3	10-15	6-8'	6'-7' ht.	B&B	columnar, shade tolerant
GHFC	1	Gracilis Hinoki Falsecypress	Chamaecyparis obtusa 'gracilis'	4	15-20	6-8'	6'-7' ht.	B&B	Pyramidal, specimen form
KOS	2	Koster Hinoki Falsecypress	Chamaecyparis obtusa 'kosteri'	5	5-6'	3-4'	6 gal.	CTN	Small Accent
low.	Eve	ergreen Ground Cover	11.2						
ELY	1	Ever-Low Yew	Taxus media 'ever-low'	4	1.5'	4-6'	18"-24" spd.	в&в	Hardy, shade tolerant
HSCP	1	Hillside Creeper Scotch Pine	Pinus sylvestris 'hillside creeper'	3	1.5	6-8'	3' spd.	B&B	natoy, shade tolerant
SMMP		Slowmound Mugo Pine	Pinus mugo 'slowmound'	2	2-3'	3-4'	6 gal.	CTN	full sun, dark green, slow growing mound
MCBS	1 52	Mrs Cesarini Spruce	Picea pungens 'mrs cesarini'	2	2-3'	4-5'	6 gal.	CTN	Flat topped bright green spruce
Accer	  t/	। Flowering Evergreen Shr	l line						
PJM		PJM Rhododendron	Rhododendron 'PJM'		C 01		21 2 4 (2)		
PRG		Purple Gem Rhododendron	Rhododendron 'Pim'	4	6-8'	6'	3'-3 1/2' ht.	B&B	full sun, hardy
BBA	100	Brouwer's Beauty Andromeda			2' 5'	4' 5'	18"-24" spd. 2'-3' ht.	CTN	full sun, hardy, low
CNW		Cunningham White Rhododendron	Pieris 'brouwer's beauty' Rhododendron cat. 'cunningham white'	5	4-5'	4-5'	2'-3' ht. 3 1/2'-4' ht.	8&B 8&B	shade, hardy
		us Flowering Shrubs				1000 - 2000			
QFPH		Little Quick Fire Panicle Hydrangea	Hydrangea paniculata 'quickfire'	3	3-4'	3-4'	3 gal.	CTN	Sun, compact form, winter hardy
FLH-3		Endless Summer Hydrangea	Hydrangea macrophylla 'blushing bride'	4	3-5'	3-5'	5 gal.	CTN	Sun, winter hardy
MFV		Cayuga Mayflower Viburnum	Viburnum carlesi	4	5-6'	5-6'	3 1/2'-4' ht.	B&B	shade tolerant, ruffled foliage, fragrant
KSD		Kelsey's Red Osier Dogwood	Cornus sericea'kelseyi'	4	2-3'	2-3'	3 gal.	CTN	sun, compact mound, purple fall color
AMJN	3	Amber Jubilee Ninebark	Physocarpus opulifolius 'amber jubilee'	2	5-6'	3-4'	5 gal.	CTN	Bold mix of colors in spring, Clusters of white flower
RVE		Redvein Enkianthus	Enkianthus campanulatus	4	8-10'	6-8'	4'-5' ht.	B&B	partial shade
ccs	3	Candy Corn Spirea	Spirea japonica 'candy corn'	4	18-24"	2-3'	3 gal.	CTN	Vivid foliage colors & blooms, compact form
Decor	ati	ive Grasses							
DCGR-4	47	Purple Lovegrass	Eragrostis spectabilis	4	18-24"	30"	1 yr. potted	2 gal.	18*-24", S, Aug/Oct, bronze-red seed heads
DCGR-5	18	The Blues Little Bluestem	Schizachyrium scoparium 'The Blues"	3	24-48"	18"	1 yr. potted	2 gal.	24 48", S/Psh, Sept/Oct, Dwarf Bluestem, Tawny Fall color
eren	nia	als/Seasonal Color							
·Sun; S	Sh - S	Sun/Shade; S/PSh - Sun and Part Shade; PS	ih - Part Shade; PSh/Sh - Part Shade/Shade						2
Sym		Common Name	Botanical Name	Zone		Growth	Туре	Size	Features Ht., Exposure, Bloom Period, Color
GC.A-1	5	Daylily	Hemerocallis 'Bama Bound'	Lone	and Mark	Spread	1 yr. potted	2 qt	24", S/PSh, June/August, Dark Red w/ Apple throat
C.A-10		Daylily	Hemerocallis 'Rosy Returns'				1 yr. potted	2 qt	16", S/PSh, June/Aug, Apricot Pink
		Daylily	Hemerocallis 'Stella de Oro'				1 yr. potted	2 qt	14*, S/PSh, June - Sept, deep golden yellow
GC.C-2	11	Pow Wow Wildberry Coneflower	Echinacea purpurea 'pow wow wildberry'				1 yr. potted		24-36", S/Psh, June/Aug, Rich Raspberry Pink
GC.L-3	11	Astilbe	Astilbe 'ostrich plume'				1 yr. potted	2 qt	24-30°, PSh/Sh, June, Dark Foliage w/ Salmon Pink
GC.B-2	8	Threadleaf Coreopsis	Coreopsis verticillata, 'Creme Brulee'				1 yr. potted	2 qt	20°, S, June/Oct, Butter Yellow

Courtyard Plant Schedule

Lawns/Seeding 0 SF Sod Fine Lawn g2+1 ac

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Project Name:

### Stevens Mill Redevelopment


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**Chinburg Properties** 3 Penstock Way Newmarket, New Hampshire 03857

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Plant Schedules

LA-3.0


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CCD	3	Golden Glory Corneliancherry (mult	Cornus mas 'golden glory'	4	15-20	10-15	6'-7'	ht.	B&B	clump
ISJTL	3	Ivory Silk Japanese Tree Lilac	Syringa reticulata 'ivory silk' Multistem	3	20-25	15'	6'-7'	ht	B&B	multistem, Cherry brown bark, dark grn foliage
LMM	2	Leonard Messel Magnolia - MULTI	Magnolia loebneri 'leonard messel'	4	15-20	10-15	8'-10	ht.	B&B	
SRW	1	Sourwood (multi)	Oxydendrum arboreum	4	25-30	20'	8'-10	ht.	B&B	
SRW	2	Sourwood	Oxydendrum arboreum	4	25-30	20'	2-1/2	" cal.	B&B	full sun
WKH	1	Winter King Hawthorn	Crataegus viridis 'winter king'	4	25-30'	20-30	2-1/2	cal.	B&B	Gray bark, showy fruits
Everg	ree	en Trees & Accent Everg	reens							
DRK	13	Dark American Arborvitae	Thuja occidentalis 'nigra'	4	10-30	10-12	6'-7'	ht.	B&B	columnar, wide base, shade tolerant
MSA	9	Mission Arborvitae	Thuja occidentalis 'techney'	3	10-15	6-8'	6'-7'	ht.	8&8	
Low,	Eve	ergreen Ground Cover								, -, -,
ВНЈ	10	Bar Harbor Juniper	Juniperus horizontalis 'par harbor'	3	1'	8'	12"-1	B" spd.	CTN	Infill ground cover
HSCP	2	Hillside Creeper Scotch Pine	Pinus sylvestris 'hillside creeper'	3	1-2'	6-8'	3'	spd.	B&B	mini ground cover
SMMP	1	Slowmound Mugo Pine	Pinus mugo 'slowmound'	2	2-3'	3-4'	6	gal.	CTN	full sun, dark green, slow growing mound
RSCP	10	Russian Cypress	Microbiata decussata	2	1-2'	4-5'	18"-2	4" spd.	CTN	Sun and shade, arborvitae like foliage
SGJ	2	Sea Green Juniper	Juniperus chinensis 'sea green'	4	5'	6'		4" spd.	CTN	Bright green, arching foliage, fountain like hab
Accer	t/I	l Flowering Evergreen Shr	ubs							x 1
PJM		PJM Rhododendron	Rhododendron 'PJM'	4	6-8'	6'	3'-3 1	/2' ht.	B&B	full sun, hardy
PRG	12	Purple Gem Rhododendron	Rhododendron 'Purple gem'	4	2'	4'	18"-2		CTN	full sun, hardy, low
Decid	uo	us Flowering Shrubs	a section of the sect							
FLH-3	4	Bombshell panicle Hydrangea	Hydrangea paniculata 'bombshell'	3	3-4'	3-4'	3	gal.	CTN	Sun, compact form, winter hardy
QFPH	4	Little Quick Fire Panicle Hydrangea	Hydrangea paniculata 'quickfire'	3	3-4'	3-4'	3	gal.	CTN	Sun, compact form, winter hardy
LDN	5	Little Devil Ninebark	Physocarpus opulifolius 'little devil'	3	3-4'	3-4'	5	gal.	CTN	sun, compact, rounded growth, Shade tolerant
JUDD	6	Judd Viburnum	Viburnum dilatatum x juddii	4	6-8'	6-8'	4-5'	ht.	B&B	red-veined leaves
BMV	8	Blue Muffin Viburnum	Viburnum dentatum 'blue muffin'	4	6-8'	4-5'	4'-5'	ht.	8&8	Pendulous habit, Vase shaped, white flower
LCN	9	Lemon Candy Ninebark	Physocarpus opulifolius 'lemon candy'	3	2-3'	2-3'	3	gal.	CTN	Yellow-green foliage, dense, compact habit
RVE	5	Redvein Enkianthus	Enkianthus campanulatus	4	8-10'	6-8'	4'-5'	ht.	B&B	partial shade
PNKV	4	Pink Dawn Viburnum	Viburnum bodnantense 'pink dawn'	3	10'	7'	4'-5'	ht.	B&B	Upright form
Decor	ati	ve Grasses	a harmonia							
DCGR-4	33	Purple Lovegrass	Eragrostis spectabilis	4	18-24"	30"	1 yr. p	otted	2 gal.	18"-24", S, Aug/Oct, bronze-red seed heads
DCGR-5	45	Carousel Little Bluestem	Schizachyrium scoparium 'carousel'	3	30"	30"	1 yr. p			30", S, Sept/Oct, Swarf Bluestem, Fall color copper to di
DCGR-6	60	Prairie Dropseed	Sporobolus heterolepis	3	24-36"	24"	1 yr.	potted		36", S/Psh, Sug, Emerald grn leaves,organge/yellow fall
Peren	nia	als/Seasonal Color								
S · Sun; S	/Sh - 5	Sun/Shade; S/PSh - Sun and Part Shade; PS	h - Part Shade; PSh/Sh - Part Shade/Shade		Unbis of	Growth				
Sym	Qty	Common Name	Botanical Name	Zone	Height		T	ре	Size	Features Ht., Exposure, Bloom Period, Colo
GC.A-1	11	Daylily	Hemerocallis 'Bama Bound'				1 yr. p		2 qt	24", S/PSh, June/August, Dark Red w/ Apple throat
GC.A-3	46	Daylily	Hemerocallis Hyperion				1 yr. p	otted	1 gal.	40", S/PSh, June/Aug, Sulfur Yellow
GC.A-9	28	Daylily	Hemerocallis flava 'Siloam Dbl. Classic'				1 yr. p	otted	2 qt	18", S/PSh, June, Double Soft Salmon Pink
GC.A-11			Hemerocallis 'purple de Oro'				1 yr. p	otted	1 gal.	20", S/PSh, June - Sept, purple flowers/yellow throat
GC.C-2		Hot Coral Coneflower	Echinacea purpurea 'hot coral'				1 yr. p	otted	1 gal.	22",S, June/Aug, Hot Coral Pink
GC.C-3		White Coneflower	Echinacea purpurea 'White Swan'				1 yr. p	110000	2 qt	18"-24",S/PSh, June/Sept, White
GC.H-5		Hosta	Hosta 'Royal Standard'				1 yr. p		1 gal.	24-28", S/Sh, Aug/Sept, White flower, Rich Grn leaf
GC.1		Walker's Slow Catmint	Nepeta Catmint 'walke's slow'				1 yr. p		2 qt	15-18", S/Psh, June/Aug, Lavender Blue
GC.L-3		Astilbe	Astilbe 'ostrich plume'				1 yr. p		2 qt	24-30", PSh/Sh, June, Dark Foliage w/ Salmon Pink
GC.X-3		Bloody Cransbill	Geranium sanguineum 'NH Purple'				1 yr. p		2 qt	
GC.ZZ.2	18	Little Goldstar Black Eyed Susan	Rudbeckia fulgida var. sullivantii 'Little Goldsta	r	I		1 yr. p	otted	1 gal.	14"-16", S/Psh, Jul/Sept, gold to Orange shades

0 SF Seeded Fine Lawn 0 SF Sod Fine Lawn

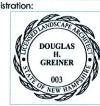- 1.) All planting beds shall be mulched with a minimum of 2" of shredded pine bark mulch.
- 2.) All sod and/or seeded lawn areas to have minimum 6" topsoil blanket. 3.) All native grass seeded areas to have minimum 4" topsoil blanket.
- 4.) All plant material to conform to current AAN, American Standard for Nursery Stock, ANSI Z60.1-2006.
- 5.) All mass planted shrub beds and planters around building shall receive a minimum 18"
- deep topsoil blanket to compensate for the very sandy/granular sub-grade material expected on this site. Topsoil shall meet requirements as called out in specification
- Overall Plant Schedule LA Sheets 1.0, 1.1, 1.2 & 1.3

Fine Grade, fertilize, seed and Hydromulch (Kentucky Bluegrass and Creep Fine Grade, fertilize, (Kentucky Bluegrass and Creeping Red Fescue Blend)

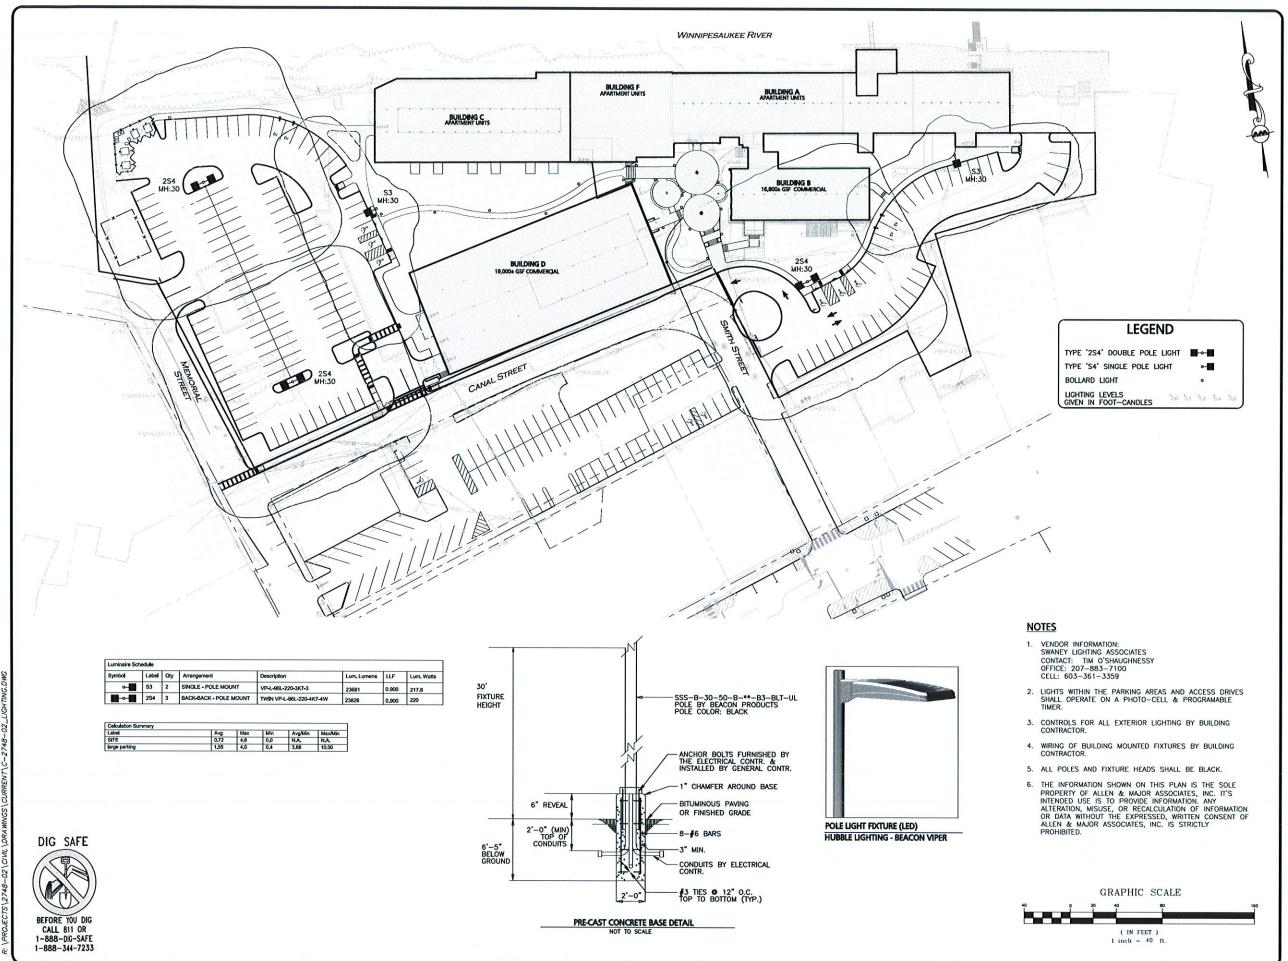

APPROVED - CITY PLANNING STAFF CHAIRMAN DATE SECRETARY DATE DATE OF APPROVAL 1 10-06-2020 ISSUED FOR SITE PLAN REVIEW
REV DATE DESCRIPTION APPLICANT\OWNER STEVENS MILL, LLC C/O CHINBURG PROPERTIES 3 PENSTOCK WAY **NEWMARKET, NH 03857** STEVENS MILL REDEVELOPMENT **20 CANAL STREET** FRANKLIN, NH 03235 PROJECT NO. 2748-02 DATE: SCALE: 1" - 40' DWG. NAME: DESIGNED BY: ARM CHECKED BY:

ALLEN & MAJOR

ASSOCIATES, INC.

civil engineering + land surveying onmental consulting + landscape architectu www.allenmajor.com

400 HARVEY ROAD MANCHESTER, NH 03103 TEL: (603) 627-5500 FAX: (603) 627-5501

WOBLEN, M. & LAKEVILLE, M. & MANCHESTER, NH

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10-06-2020

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SITE LIGHTING PLAN